	TABLE 1 LEGEND	QTY.
XXXXX	SAMPLE NUMBER	
•	SAMPLE LOCATION NUMBER	
XXXXX	POSITIVE SAMPLE NUNBER	
	EXTERIOR WHITE PAINT	81,000 S.F
W	WINDOW GLAZING	685 S.F
0	OVERHEAD DOOR	
	9x9 FLOOR TILE - GREEN, BROWN, WHITE, GREY	
	9x9 FLOOR TILE MASTIC	
	12x12 FLOOR TILE - GREEN, BROWN, WHITE, RED, BLACK, TAN	
+ + +	12x12 FLOOR TILE MASTIC	
88	LINOLEUM	
	2x2 CEILING TILES	
	THERMAL SYSTEM INSULATION LARGE AND SMALL DIAMETER	
0	PIPE FITTINGS	
West Control of the C	TRANSITE WALL PANEL	QUANTITIES LISTED BY
\$	TRANSITE CEILING	FLOOR ON DRAWINGS
H	TRANSITE HOOD	ASB101 THRU ASB110
P	PANEL ADHESIVE	BOILER ROOM
L	LAB COUNTERTOP	AND COMPRESSOR ROOM QUANTITIES LISTED SEPARATELY
S	SINK SOUND COAT	LIGITED SEPARATELI
	VERMICULITE	
B	BLACK SEALANT	
	4" BLACK COVE BASE AND MASTIC	
* *	WHITE CEILING PAINT	
^	INTERIOR SILVER PAINT	
O	EXTERIOR GALBESTOS SIDING	
G	GREEN WALL PAINT	
J	JOINT COMPOUND	
	DEBRIS	
	DUCT / TANK INSULATION	

	TABLE 2 LEGEND	QTY.
	BOILER ROOM	
	DUCT / TANK INSULATION	15,000 S.F.
0	PIPE FITTINGS	50 EACH
^	SILVER PAINT ON BOILERS / BEAMS	6,500 S.F.
	THERMAL SYSTEM INSULATION LARGE AND SMALL DIAMETER	900 L.F.
w	WINDOW GLAZING	LISTED IN TABLE 1
	COMPRESSOR ROOM	
	THERMAL SYSTEM INSULATION LARGE AND SMALL DIAMETER	1,300 L.F.
0	PIPE FITTINGS IN COMPRESSOR ROOM	55 EACH
(W)	WINDOW GLAZING	LISTED IN TABLE 1

	TABLE 3 LEGEND	QTY.
	ROOF	
	PERIMETER FLASHING / TAR	
C	CAPSTONE CAULK	
F	TAR / FACEBOARD	
	BUILT UP ROOFING	
04/2	PITCH	
V	VAPOR BARRIER UNDER COPING STONES	QUANTITIES
1111	VAPOR BARRIER	LISTED ON ASB111
P	PENETRATION TAR	
S	SHINGLES	
	TOP HOT MOP	
++++	DUCT TAR	
T	TAR COATING	
	PAINT COATING ON PARAPIT ROOFS	

ASB101 FIRST FLOOR - STRAINED FOOD BUILDING - RETORT AREA AND FILLING ROOM BUILDINGS - #4, #20, #35, #36, #60, #66 AND #68 ASB102 FIRST FLOOR - PARTIAL PLANT LAYOUT BUILDINGS - #3, #4, #5, #6, #7, #8, #15, #16, #17, #23 AND #60 ASB103 FIRST FLOOR - PARTIAL PLANT LAYOUT BUILDINGS - #4, #21, #25, #37, #47 AND #65 ASB104 SECOND FLOOR - PARTIAL PLANT LAYOUT BUILDINGS - #4, #21, #25, #37, #47 AND #65 ASB105 SECOND FLOOR - PARTIAL PLANT LAYOUT BUILDINGS - #4, #7, #20, #22, #35, #36, #60 AND #66 ASB106 SECOND FLOOR - PARTIAL PLANT LAYOUT BUILDINGS - #17, #19, #21, #47 AND #65 ASB107 THIRD FLOOR - PARTIAL PLANT LAYOUT BUILDINGS - #3, #4, #5, #6, #7, #8, #15, #16, #17, #19, #21, #23 AND #60 ASB108 THIRD FLOOR - STRAINED FOOD BUILDING BUILDINGS - #4, #7, #20, #22, #35, #36, #60 AND #66 ASB109 FOURTH FLOOR - PARTIAL PLANT LAYOUT BUILDINGS - #3, #4, #5, #6, #7, #15, #16, #17, #23 AND #60 ASB109 FOURTH FLOOR - PARTIAL PLANT LAYOUT BUILDINGS - #3, #4, #5, #6, #7, #15, #16, #17, #23 AND #60 ASB100 FOURTH FLOOR - PARTIAL PLANT LAYOUT BUILDINGS - #3, #4, #5, #6, #7, #15, #16, #17, #23 AND #60 ASB100 FOURTH FLOOR - STRAINED FOOD BUILDING BUILDINGS - #3, #4, #5, #6, #7, #15, #16, #17, #23 AND #60

ASSUMPTIONS AND LIMITATIONS

ASB 111 ROOF PLAN

- AMBIENT'S SELECTION OF SAMPLE LOCATIONS AND FREQUENCY OF SAMPLING WAS BASED ON OBSERVATIONS AND THE ASSUMPTION THAT LIKE MATERIALS IN THE SAME AREA ARE HOMOGENEOUS IN CONTENT.
- NO PROCESS EQUIPMENT WAS INSPECTED AS PART OF THIS BUILDING SURVEY. PROCESS EQUIPMENT MAY CONTAIN ASBESTOS.
- NO ELECTRICAL EQUIPMENT, WIRING, OR OTHER ELECTRICAL COMPONENTS WERE INSPECTED AS THE BUILDING POWER WAS LIVE AT THE TIME OF THE SURVEY. THESE SYSTEMS MAY CONTAIN ASBESTOS.
- THE INSIDE OF DUCT WORK, PIPING, BOILERS, AND OTHER BUILDING MECHANICAL SYSTEMS
 WERE NOT INSPECTED AS THESE SYSTEMS ARE OPERATIONAL AND INACCESSIBLE AND
 COMPLETE DESTRUCTION OR DISASSEMBLY IS REQUIRED TO GAIN ACCESS. THESE ITEMS MAY
 CONTAIN ASBESTOS.
- AMBIENT PERSONNEL DID NOT ENTER LABELED CONFINED SPACES AS PART OF THIS SURVEY. EFFORTS WERE MADE TO OBSERVE THE CONTENTS OF CONFINED SPACES BUT THESE AREAS MAY CONTAIN ADDITIONAL ASBESTOS. THERE ARE AREAS OF THE STRUCTURES THAT ARE NOT SAFE TO ENTER SUCH AS THE BASEMENT UNDER THE STRAINED FOOD PROCESSING FLOOR.
- THE CORING OF SOLID WALLS, FLOORS, CEILINGS, ROOF DECKS, AND OTHER SOLID SURFACES
 WAS NOT IN THE SCOPE OF WORK AND WAS NOT PERFORMED AS PART OF THIS SURVEY.
 ASBESTOS MAY BE FOUND WITHIN OR BEHIND THESE SURFACES UPON DEMOLITION.
 AMBIENT DID NOT PERFORM DEMOLITION TO ACCESS INTERSTITIAL SPACES.
- AMBIENT DID NOT INSPECT ANY EXTERIOR AREAS BELOW GRADE. FOUNDATION SEALERS, BURIED PIPING, AND OTHER ITEMS MAY EXIST BELOW GRADE WHICH MAY CONTAIN ASBESTOS.

VAULT DOORS, WALLS, FLOORS, AND CEILINGS WERE NOT DRILLED OR DAMAGED AS PART

OF THIS SURVEY. THESE DOORS MAY OR MAY NOT CONTAIN ASBESTOS.

THE EXTERIOR COATING HAS BEEN FOUND UNDER CAP STONES, ALUMINUM PARAPET WALL CAPS, AND IN OTHER CONCEALED SPACES. THIS MATERIAL IS IN NON-FRIABLE CONDITION ON MUCH OF THE STRUCTURE BUT IS DAMAGED AND FRIABLE IN OTHER AREAS SUCH AS AT ROOF LEVEL WHERE EXTENSIVE WEATHERING HAS OCCURRED. THIS MATERIAL MAY EXIST

ON THE INTERIOR AS WELL IN AREAS WHERE ADDITIONS HAVE BEEN CONSTRUCTED AND

- THE FORMER EXTERIOR WALL IS NOW AN INTERIOR WALL.

 SOME ASBESTOS CONTAINING MATERIALS SUCH AS FLOOR TILE IS LOCATED UNDER ADDITIONAL LAYERS OF FLOORING, CARPETING, OR OTHER MATERIALS. THE CONTRACTOR OR OTHER USER IS ADVISED TO PHYSICALLY INSPECT THE AREAS TO BE REMOVED, TO BE BID FOR REMOVAL, OR FOR ANY OTHER PURPOSE.
- FLOOR LEVELERS, SEAM SEALERS, ADHESIVES, CONCRETE SEALERS AND OTHER MATERIALS
 BELOW FLOORING LAYERS MAY EXIST. THE LIMITED DESTRUCTIVE NATURE OF SAMPLING
 MAY NOT HAVE DISCOVERED THESE MATERIALS AS ONLY SMALL AREAS OF LARGE
 EXPANSES OF FLOORING ARE ACCESSED. THE REMOVAL OF FLOORING AND MASTICS IS TO
 INCLUDE THE REMOVAL OF THESE ITEMS AS WELL AND ALL OTHER MATERIALS DOWN TO
 THE CONCRETE SUBSTRATE.
- VERMICULITE INSULATION WAS FOUND IN AN AREA OF THE PLANT AS IDENTIFIED ON THE ATTACHED DRAWINGS. THIS MATERIAL WAS NOT DISCOVERED IN OTHER AREAS OF THE PLANT BUT MAY HAVE BEEN SPORADICALLY APPLIED IN SUCH AREAS AS THE INSIDE OF CHASES, INSIDE THE CAVITIES OF BLOCK WALLS, DUCT PENETRATIONS, OR OTHER AREAS. CURRENTLY, THERE IS NO APPROVED ANALYTICAL METHODOLOGY TO CONFIRM VERMICULITE AS NON ASBESTOS, THEREFORE IT AUTOMATICALLY HAS TO BE CONSIDERED TO BE CONTAMINATED WITH ASBESTOS IN NEW YORK STATE, AND IF ENCOUNTERED DURING DEMOLITION MUST BE HANDLED AS AN ASBESTOS CONTAINING MATERIAL.
- THERE ARE SOME AREAS OF THE PLANT THAT WERE INACCESSIBLE TO THE INSPECTION
 TEAM. THESE AREAS MAY CONTAIN ASBESTOS CONTAINING MATERIALS. MEASURES HAVE BEEN
 TAKEN TO IDENTIFY CONCEALED, INACCESSIBLE AREAS THAT MAY CONTAIN ASBESTOS
 MATERIALS SUCH AS WET WALLS, VAULTS, ETC.
- ALL ASBESTOS LOCATIONS ON DRAWINGS ARE APPROXIMATE AND ALL QUANTITIES ARE ESTIMATED. ANY CONTRACTOR OR OTHER USER OF THIS REPORT IS REQUIRED TO PHYSICALLY CONFIRM THE QUANTITIES OF MATERIALS TO BE REMOVED, TO BE BID FOR REMOVAL, OR FOR ANY OTHER PURPOSE. CONTRACTORS ARE RESPONSIBLE TO PHYSICALLY VISIT THE SITE AND CONFIRM ALL QUANTITIES FOR BIDDING PURPOSES.



FOR

SURVE

-DEMOLITION

28

0

ASBEST(BEECH

DRAWN BY H.J.T

AS NOTED

SITE

LOCATION MAP AND TABLE OF

CONTENTS

ASB100

JANUARY 2012

CHECKED BY

JOB NO.
DATE

TITLE

DWG. NO.

EAST MAIN STREET

KEY PLAN

ATION

	QTY.	
XXXXX	SAMPLE NUMBER	N/A
•	SAMPLE LOCATION NUMBER	N/A
*XXXXXXX	POSITIVE SAMPLE NUMBER	N/A
	EXTERIOR WHITE PAINT	SEE NOTE 1
	THERMAL SYSTEM INSULATION LARGE AND SMALL DIAMETER	100 L.F.
0	PIPE FITTINGS	4 EACH
	DEBRIS	120 S.F.
esse Varencia – Veil	DUCT / TANK INSULATION	375 S.F.

SEE SHEET 2/ASB101-

	LEGEND - SEE 2/ASB101 (TUNNELS 1 & 2)	QTY.
XXXXX	SAMPLE NUMBER	N/A
•	SAMPLE LOCATION NUMBER	N/A
XXXXX	POSITIVE SAMPLE NUMBER	N/A
	THERMAL SYSTEM INSULATION LARGE AND SMALL DIAMETER	100 S.F.
0	PIPE FITTINGS	1 EACH
O	EXTERIOR GALBESTOS SIDING	5,000 S.F.

	LEGEND - SEE 3/ASB101 (TUNNELS 3 & 4)	QTY.
XXXXX	SAMPLE NUMBER	N/A
0	SAMPLE LOCATION NUMBER	N/A
XXXXX	POSITIVE SAMPLE NUMBER	N/A
	THERMAL SYSTEM INSULATION LARGE AND SMALL DIAMETER	240 S.F
•	PIPE FITTINGS	40 EACH
	DEBRIS	1,000 S.F
	EXTERIOR GALBESTOS SIDING	3,750 S.F
EEO O D EEO	EXTERIOR WHITE PAINT	SEE NOTE

- SEE SHEET 3/ASB101

			_	
M	01	T	e	

CANAJOHARIE CREEK


RETORTS


CANAJOHARIE GREEK

- SEE ASB100 FOR TOTAL QUANTITIES


FILLING LINE #3

FILLING LINE #2

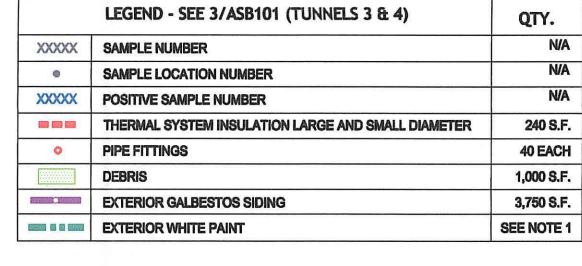


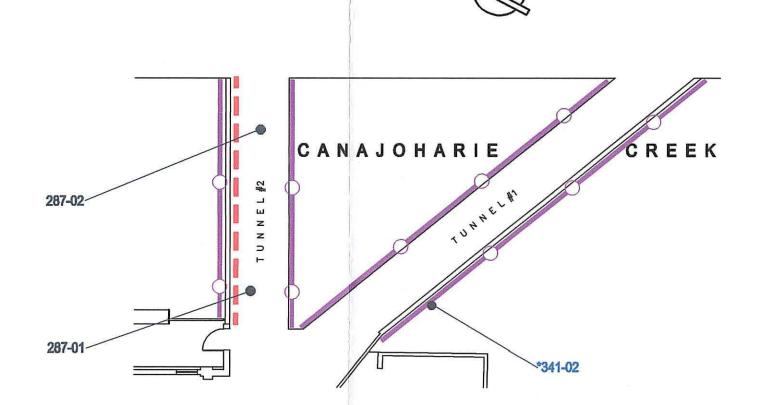

2 FIRST FLOOR TUNNELS #1 & 2 (SOUTH EAST)
SCALE: 1/16*=1*-0*

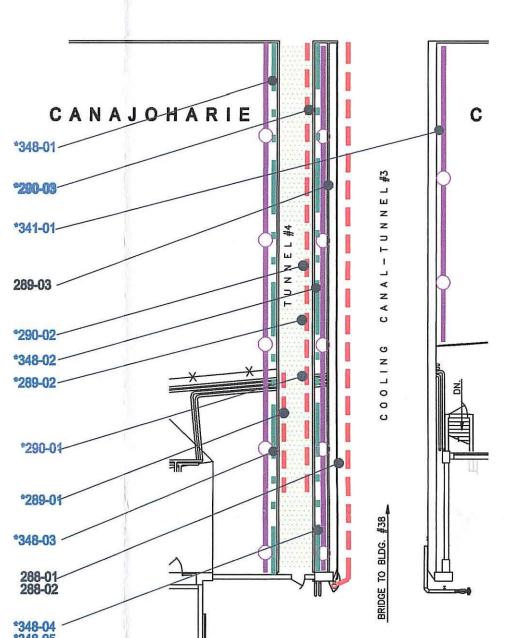

3 FIRST FLOOR TUNNELS #3 & 4 (NORTH EAST)
SCALE:1/16*=1'-0*

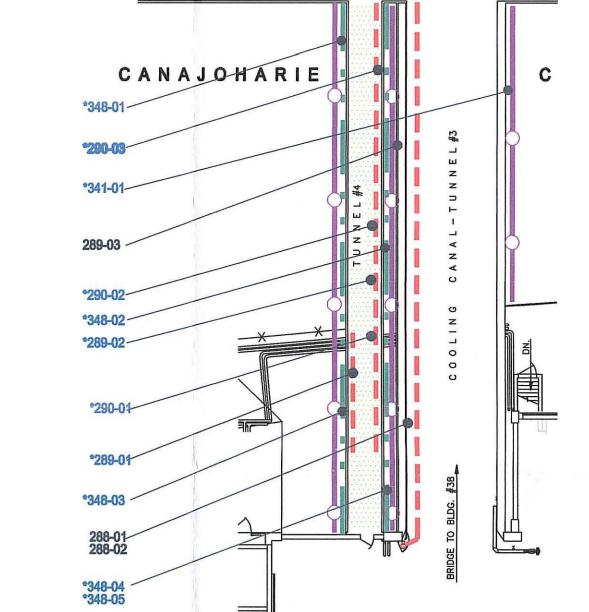

DRAWN BY H.J.T CHECKED BY AS NOTED 111110AA JANUARY 2012

SURVEY FOR

-DEMOLITION

ASBESTOS BEECH-NI

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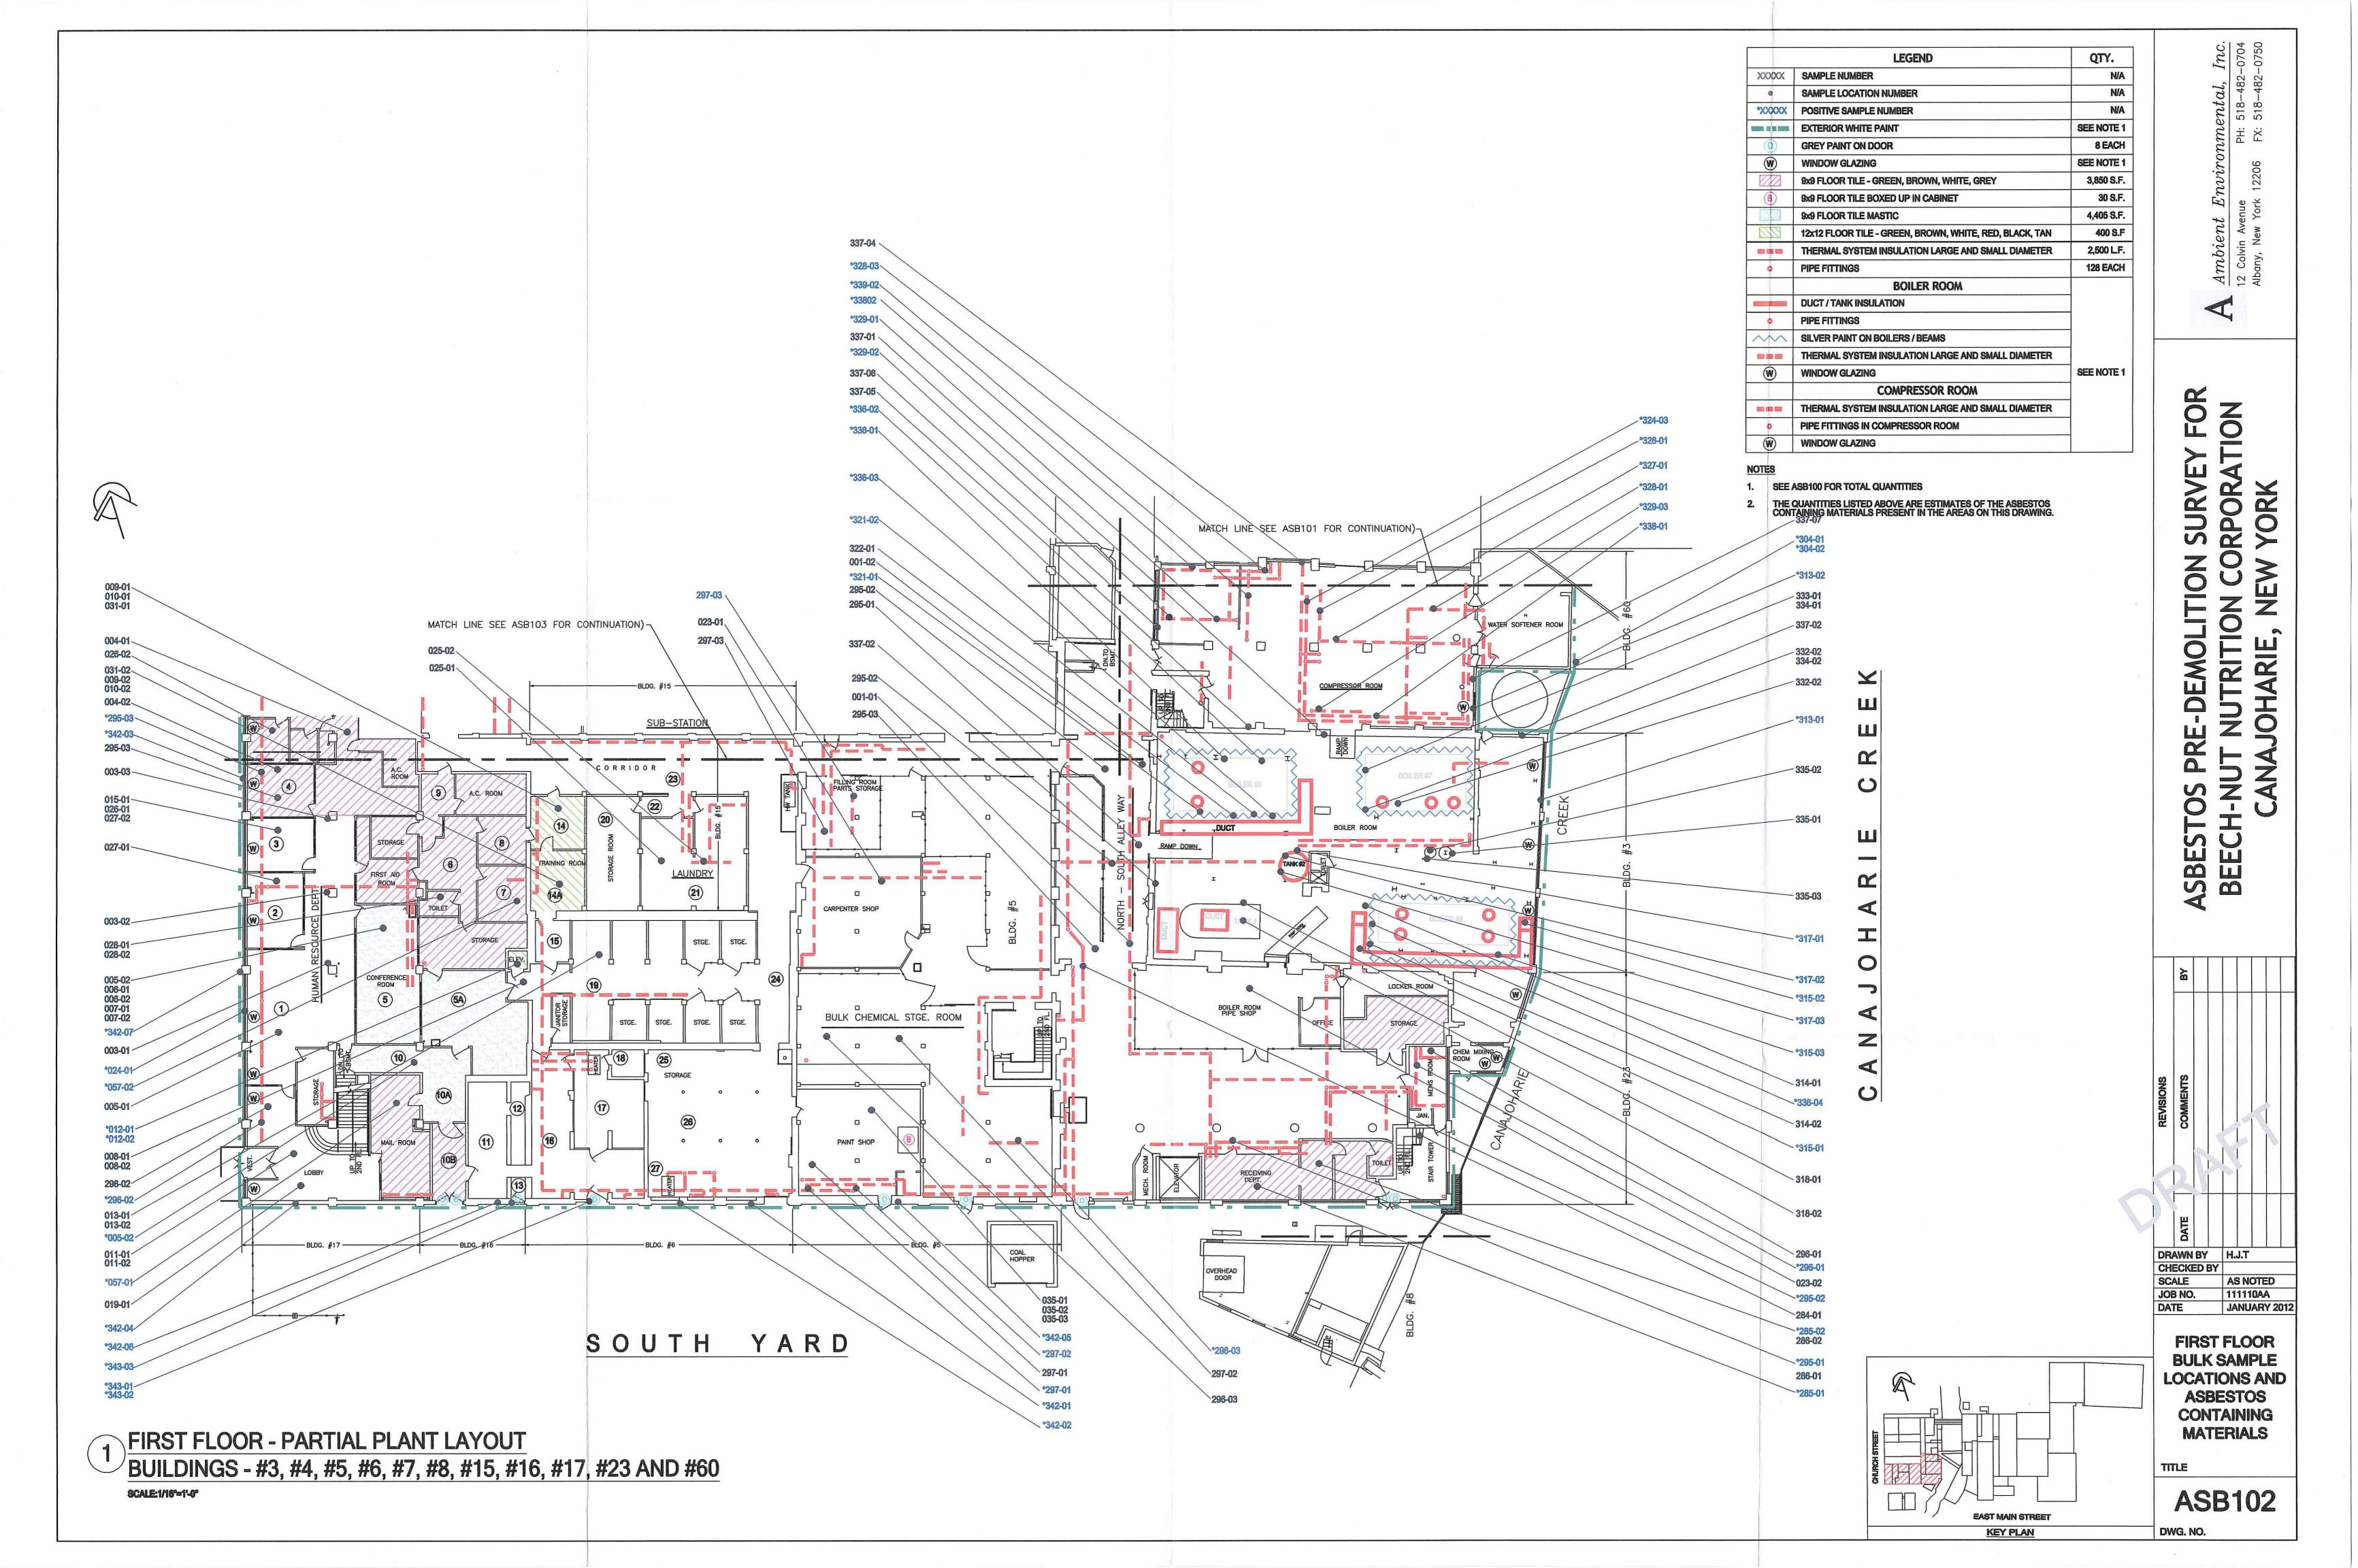
FIRST FLOOR **BULK SAMPLE LOCATIONS AND ASBESTOS** CONTAINING **MATERIALS**


ASB101

DWG. NO.

KEY PLAN

FIRST FLOOR - STRAINED FOOD BUILDING - RETORT AREA AND FILLING ROOM BUILDINGS - #4, #20, #35, #36, #60, #66 AND #68



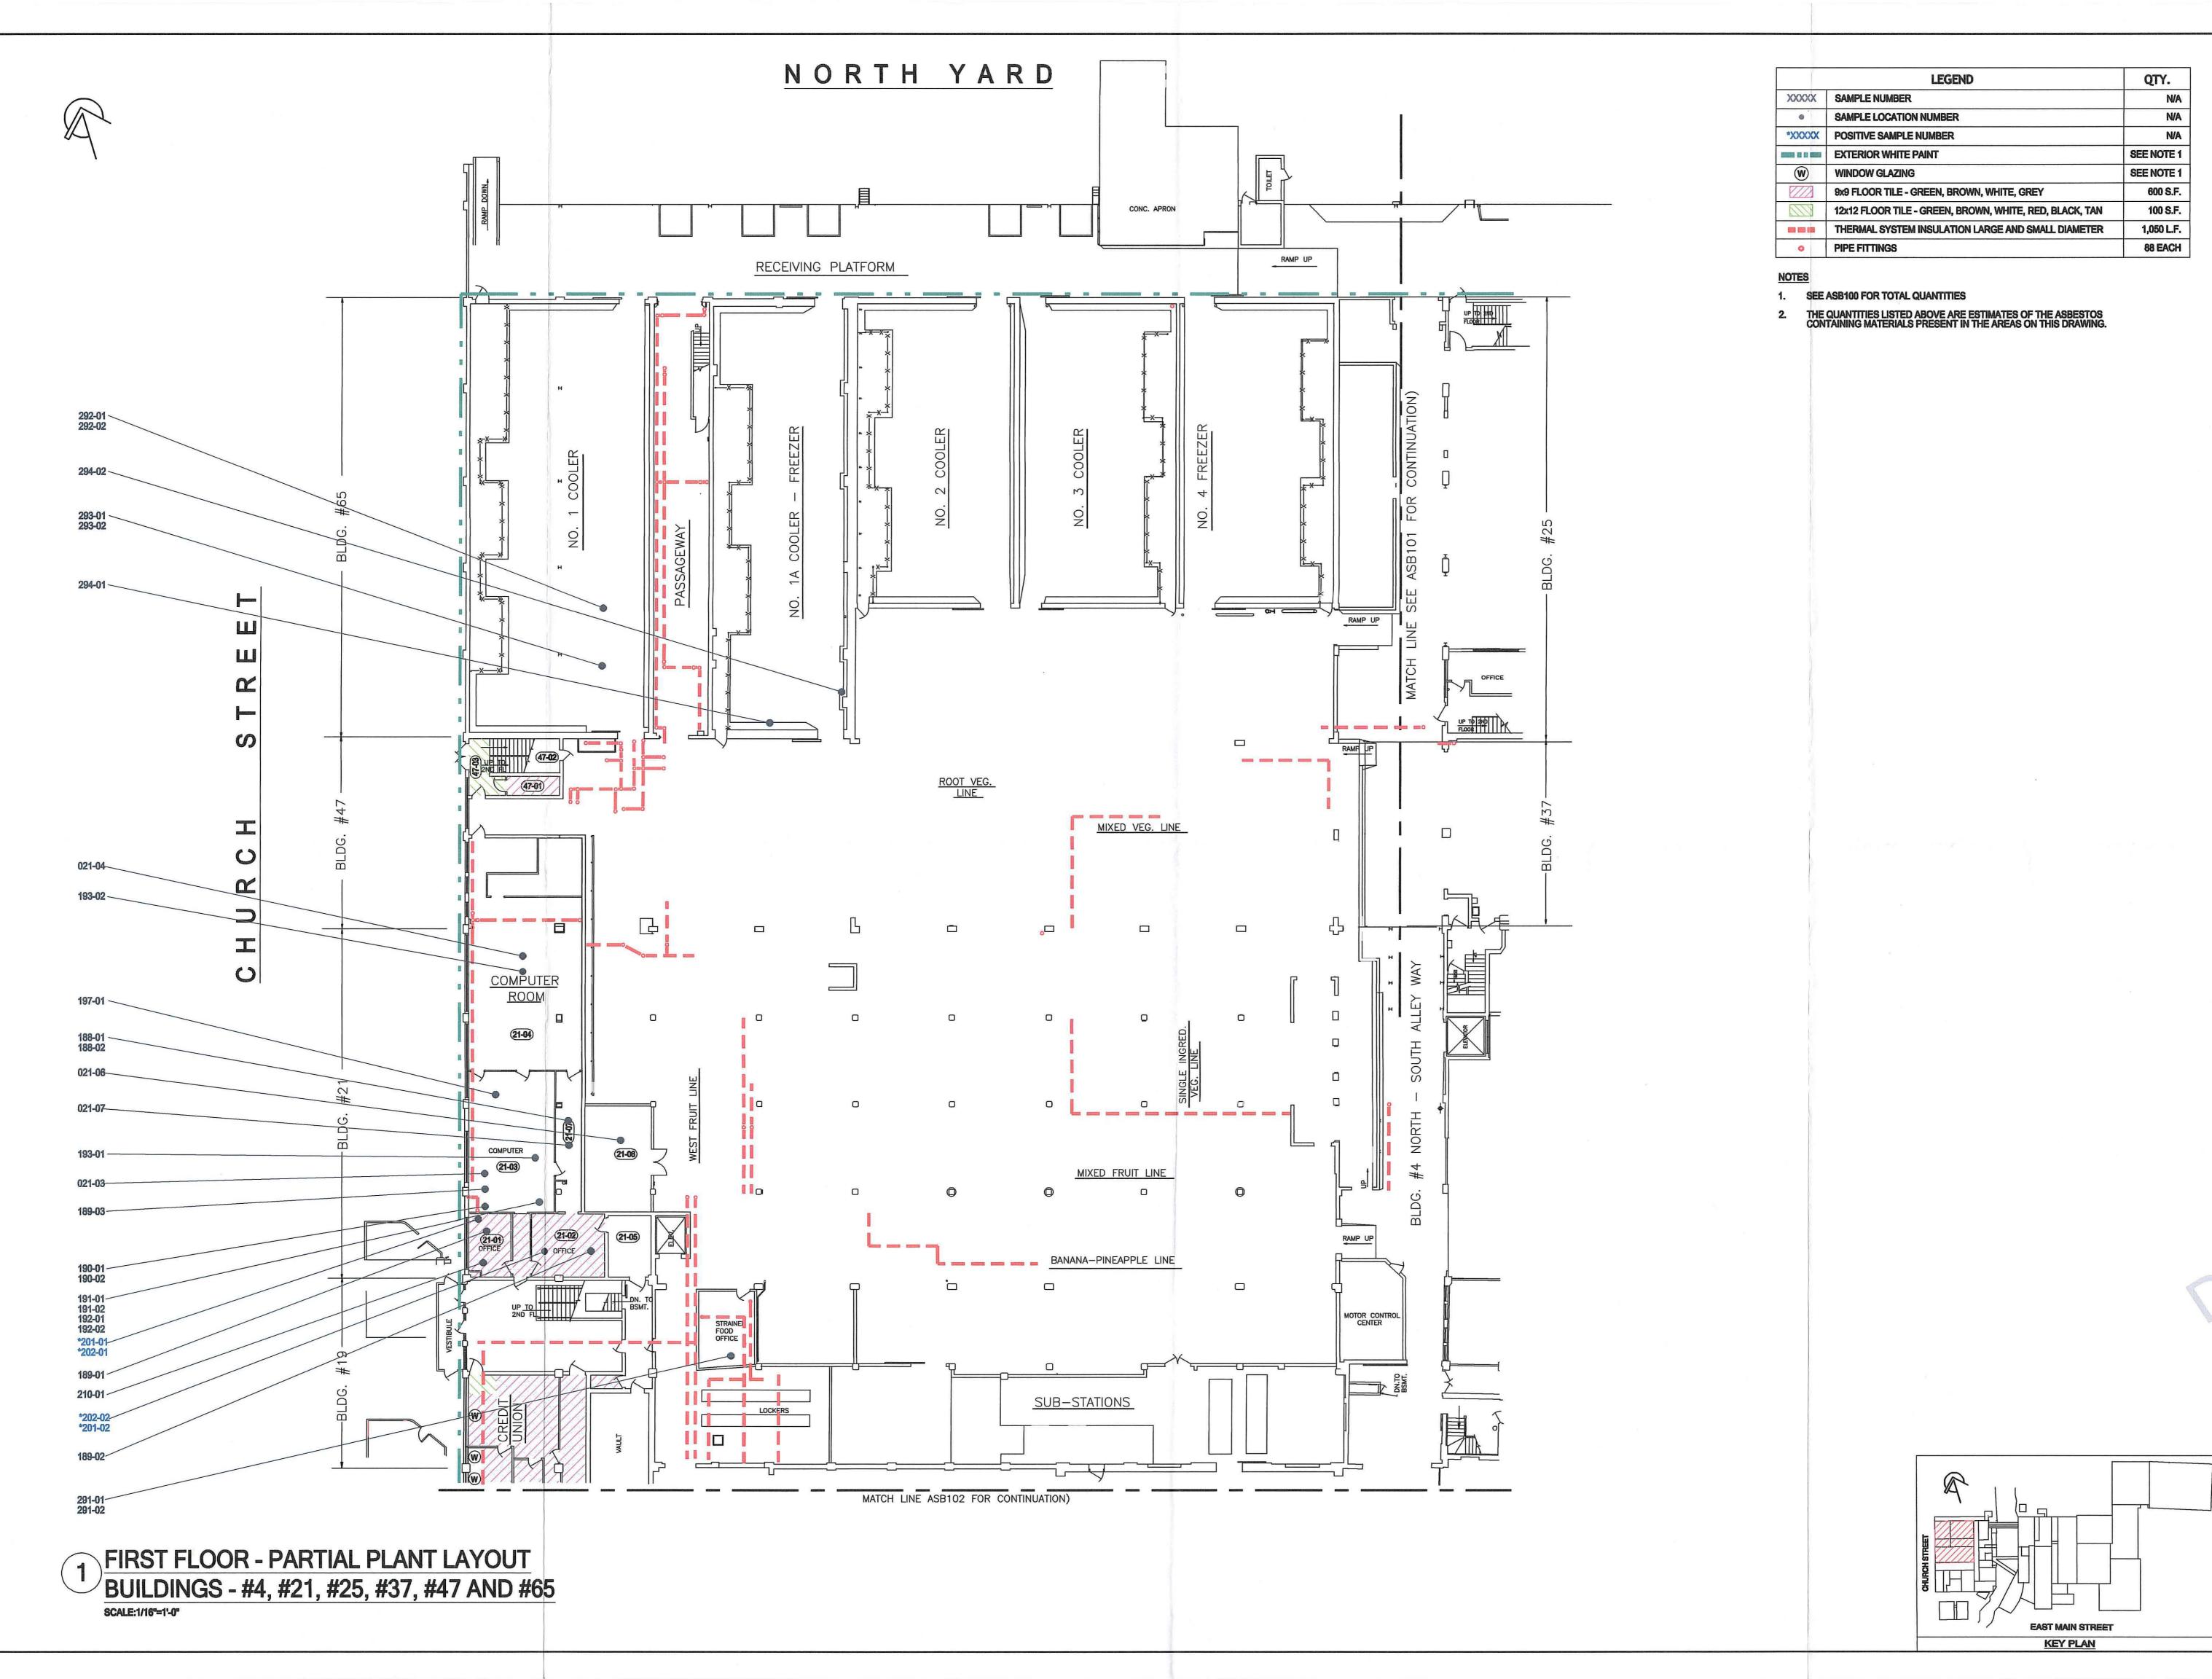

 $ient\ Environmental,\ Inc.$ vin Avenue PH: 518-482-0704, New York 12206 FX: 518-482-0750

ASBESTOS PRE-DEMOLITION SURVEY FOR BEECH-NUT NUTRITION CORPORATION

DRAWN BY H.J.T
CHECKED BY
SCALE AS NOTED
JOB NO. 111110AA


FIRST FLOOR
BULK SAMPLE
LOCATIONS AND
ASBESTOS
CONTAINING

TLE

ASB103

MATERIALS

DWG. NO.

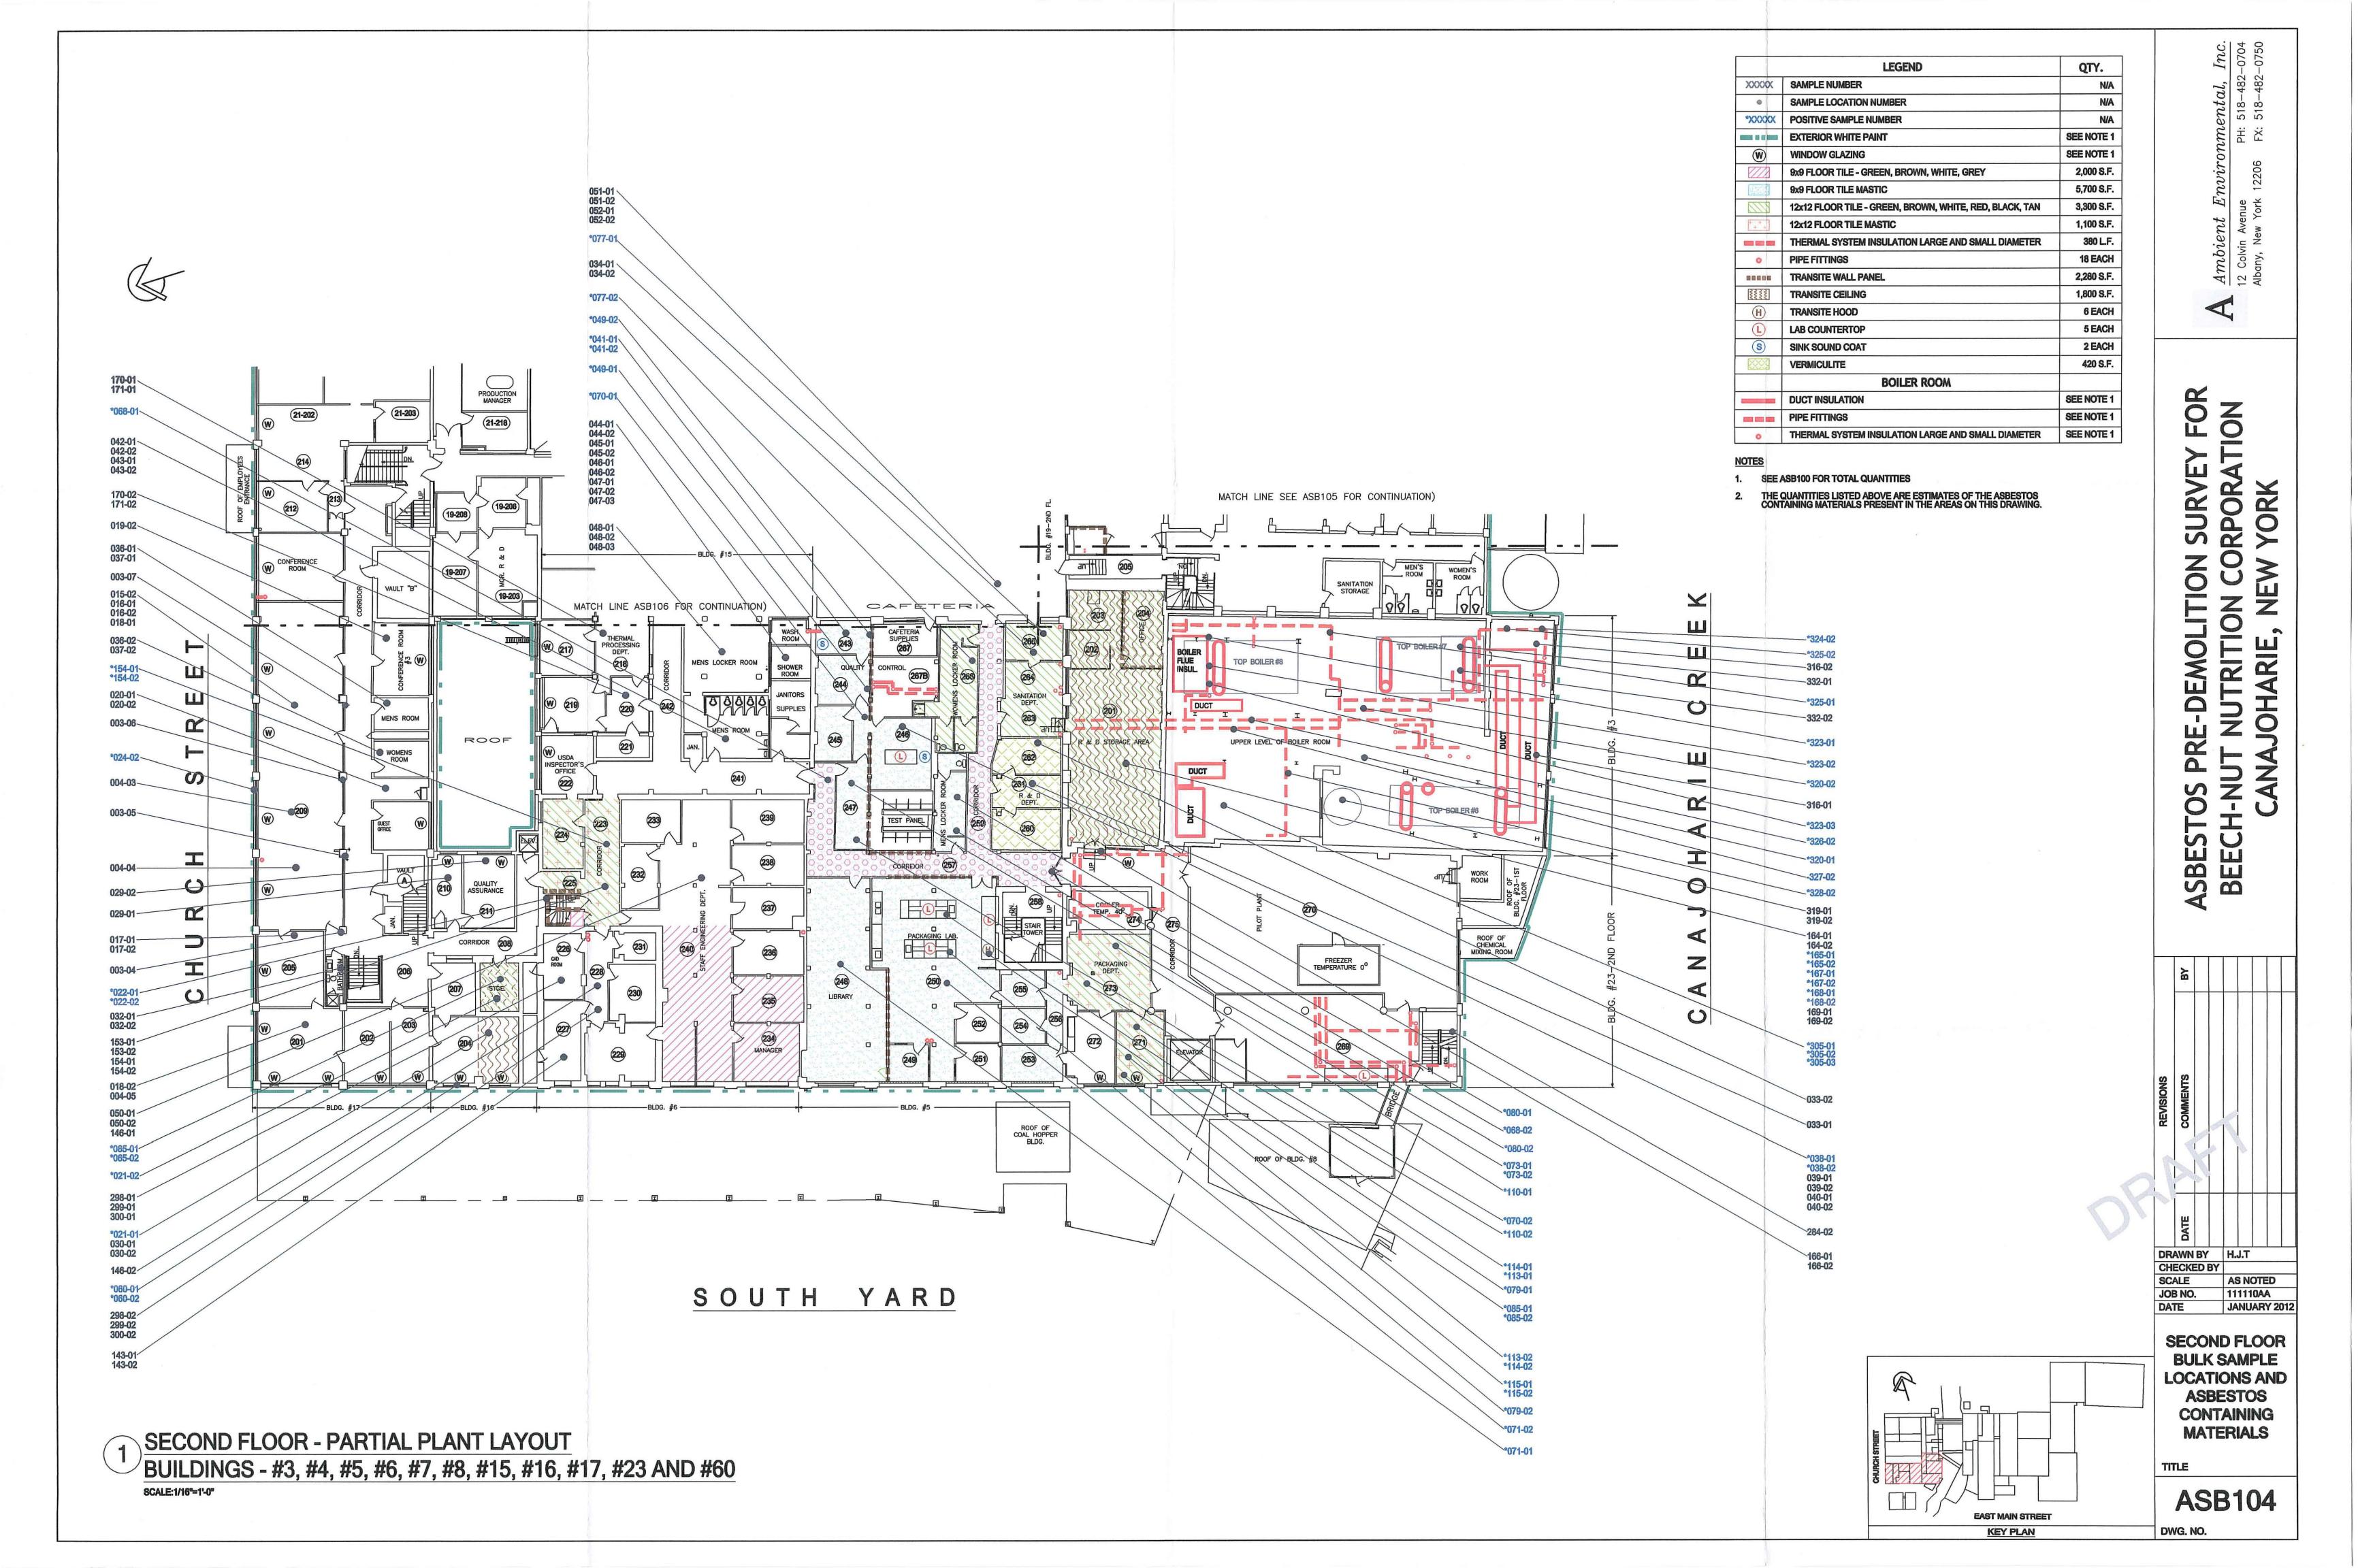





	LEGEND	QTY.
XXXXX	SAMPLE NUMBER	N/A
0	SAMPLE LOCATION NUMBER	N/A
*XXXXXX	POSITIVE SAMPLE NUMBER	N/A
	EXTERIOR WHITE PAINT	SEE NOTE
	12x12 FLOOR TILE - GREEN, BROWN, WHITE,. RED, BLACK, TAN	300 S.F
	THERMAL SYSTEM INSULATION LARGE AND SMALL DIAMETER	450 L.F
0	PIPE FITTINGS	28 EACH

NOTES

- . SEE ASB100 FOR TOTAL QUANTITIES
- 2. THE QUANTITIES LISTED ABOVE ARE ESTIMATES OF THE ASBEST CONTAINING MATERIALS PRESENT IN THE AREAS ON THIS DRAW

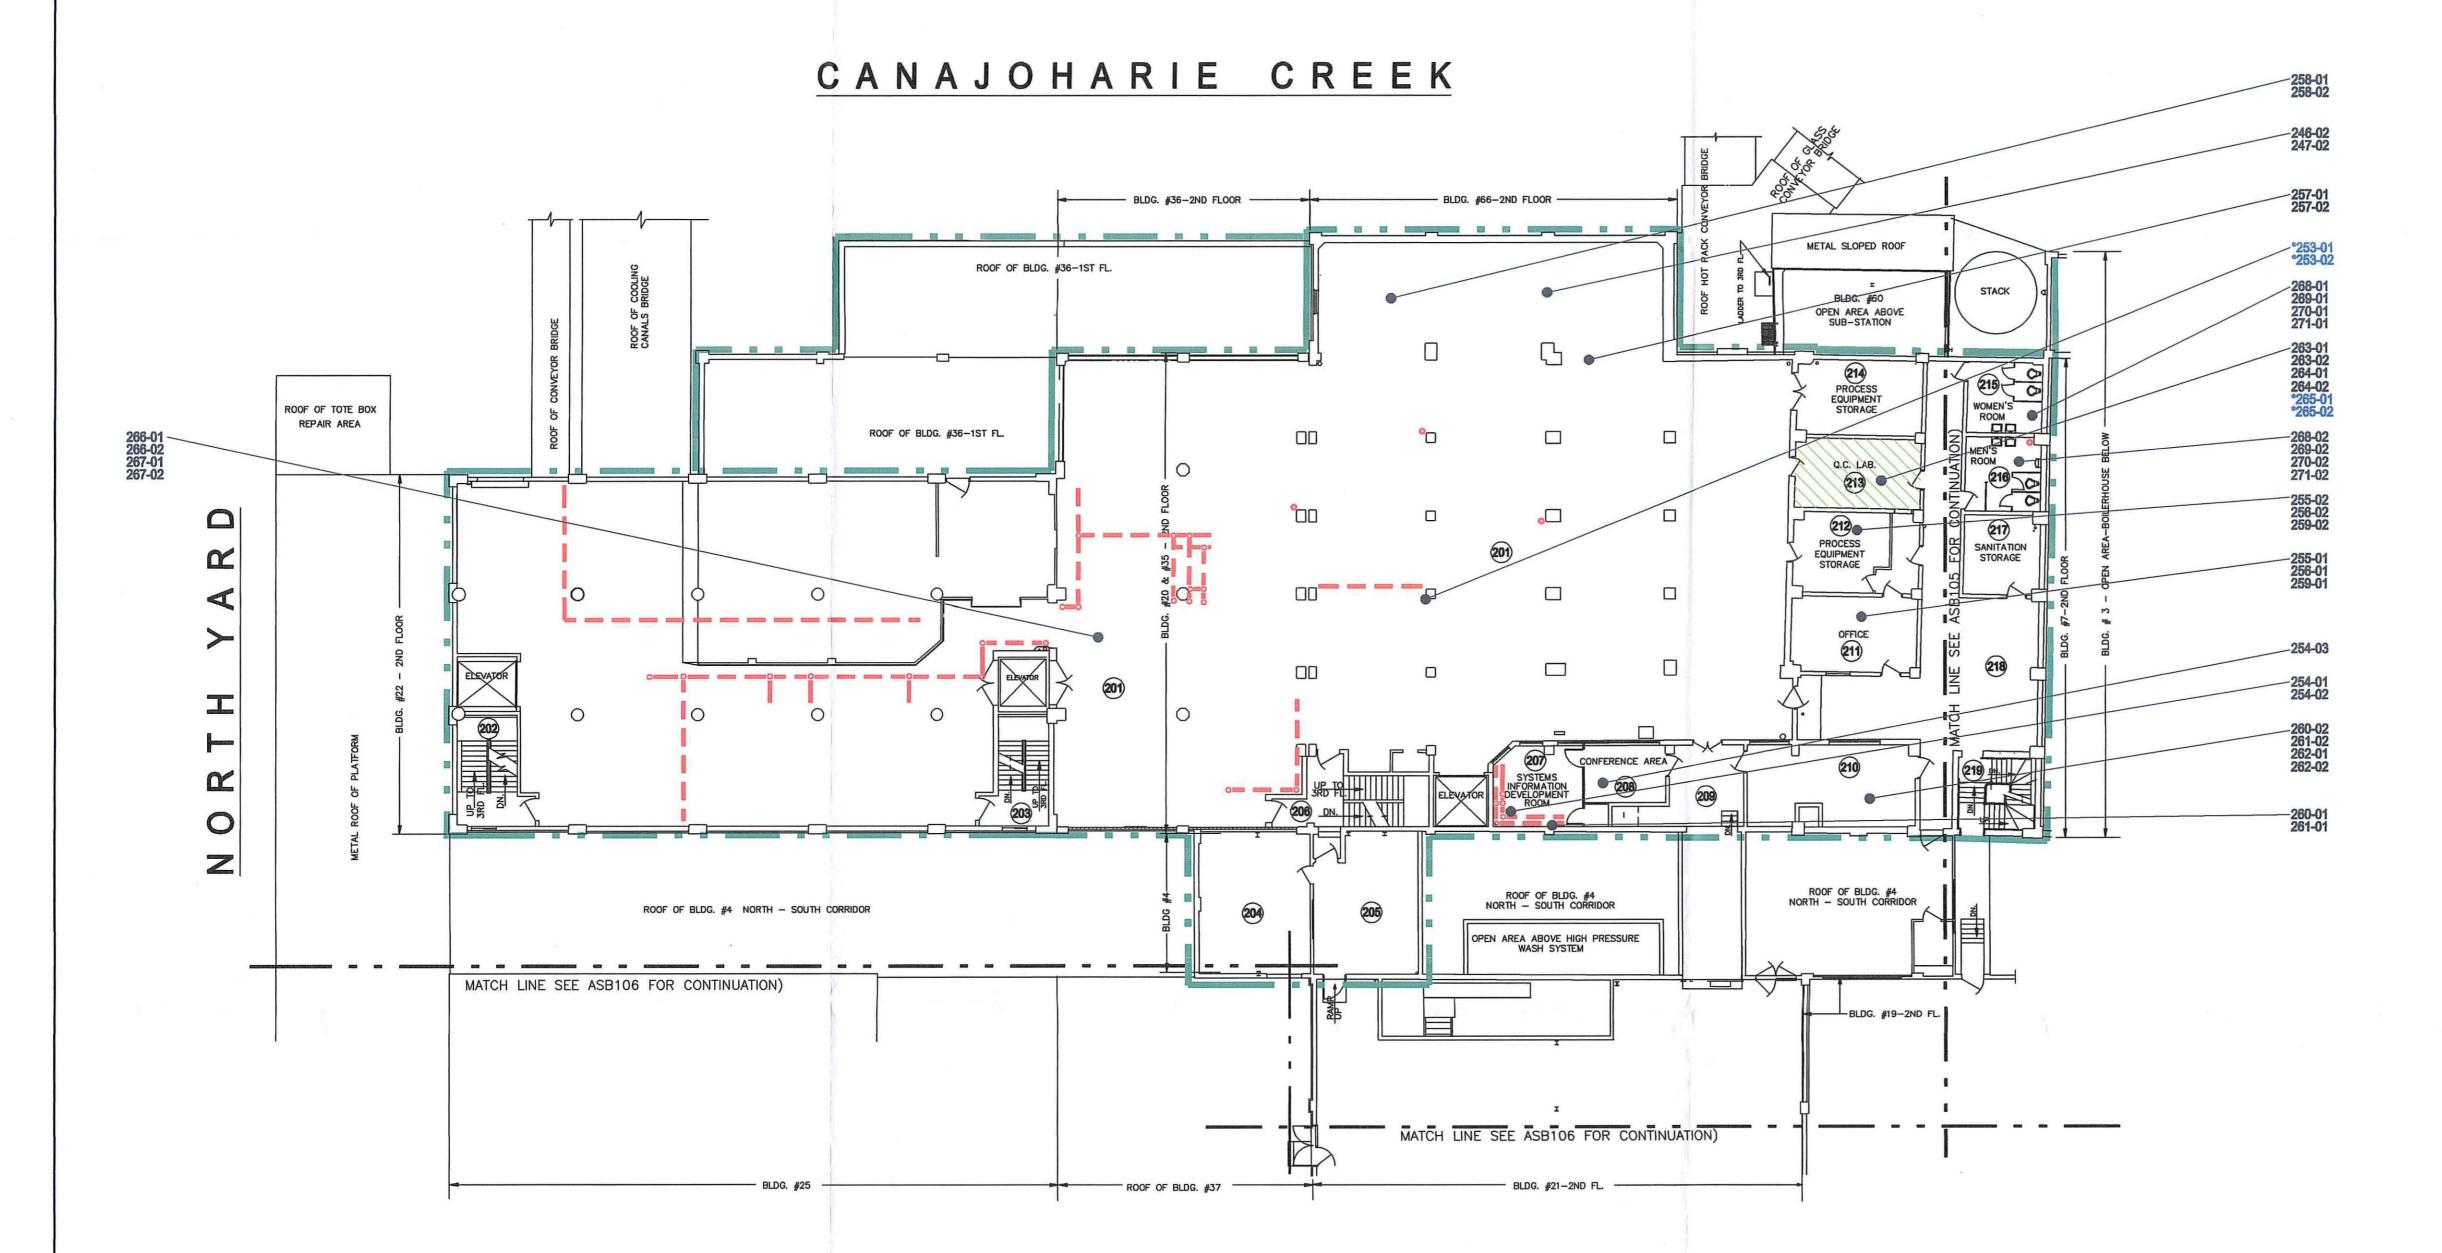

1 SECOND FLOOR - STRAINED FOOD BUILDING BUILDINGS - #4, #7, #20, #22, #35, #36, #60 AND #66

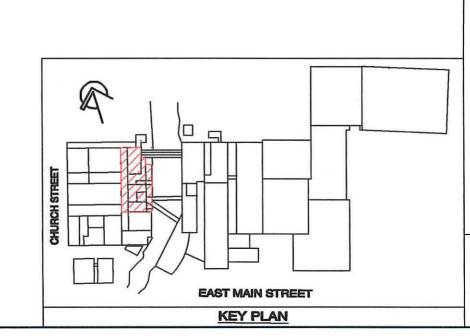

ASBESTOS PRE-DEMOLITION SURVEY FOR BEECH-NUT NUTRITION CORPORATION


DRAWN BY H.J.T
CHECKED BY
SCALE AS NOTED
JOB NO. 111110AA
DATE JANUARY 2012

SECOND FLOOR

SECOND FLOOR
BULK SAMPLE
LOCATIONS AND
ASBESTOS
CONTAINING
MATERIALS

ASB105

DWG. NO.

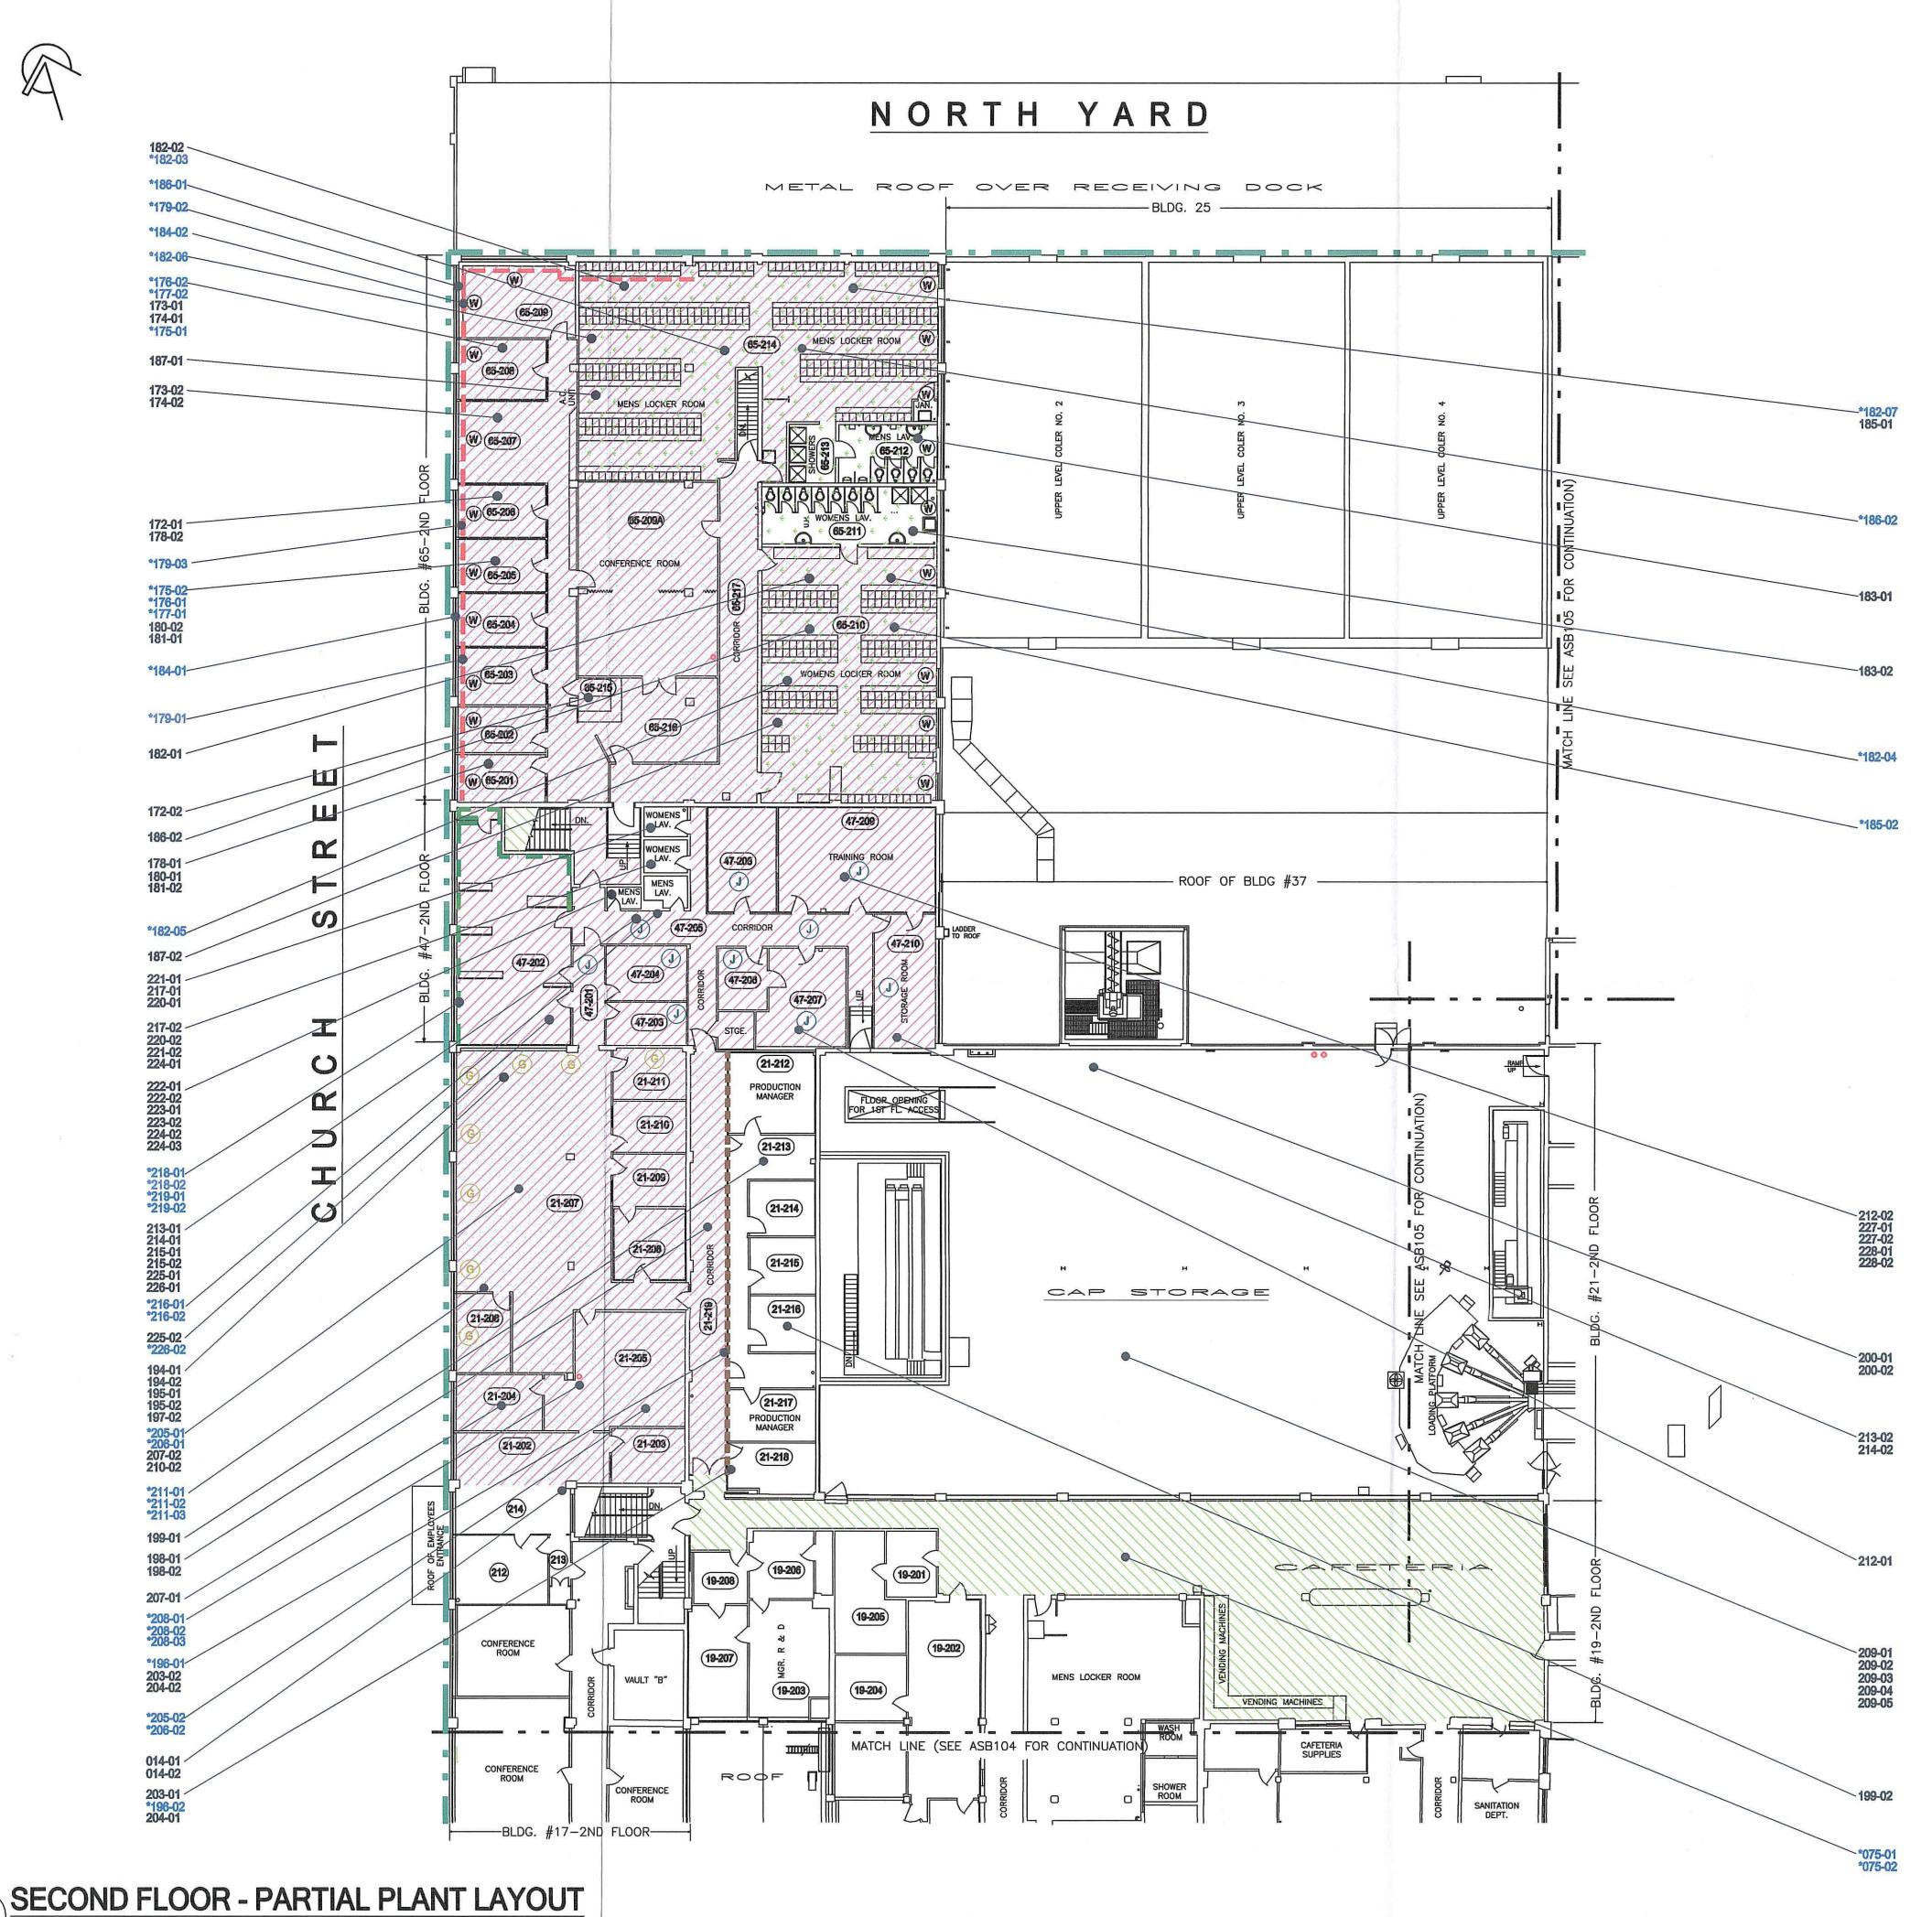

	LEGEND	QTY.
XXXXXX	SAMPLE NUMBER	N/A
0	SAMPLE LOCATION NUMBER	N/A
XXXXXX	POSITIVE SAMPLE NUMBER	N/A
	EXTERIOR WHITE PAINT	SEE NOTE 1
W	WINDOW GLAZING	SEE NOTE 1
///	9x9 FLOOR TILE - GREEN, BROWN, WHITE, GREY	15,300 S.F.
	9x9 FLOOR TILE MASTIC	11,900 S.F.
	12x12 FLOOR TILE - GREEN, BROWN, WHITE, RED, BLACK, TAN	3,700 S.F.
	THERMAL SYSTEM INSULATION LARGE AND SMALL DIAMETER	140 L.F.
0	PIPE FITTINGS	2 EACH
88086	TRANSITE WALL PANEL	100 S.F.
	4" BLACK COVE BASE AND MASTIC	160 L.F.
	WHITE CEILING PAINT	4,500 S.F.
G	GREEN WALL PAINT	300 S.F.
(J)	JOINT COMPOUND ON SHEETROCK WALLS	1,300 S.F.


NOTES

- 1. SEE ASB100 FOR TOTAL QUANTITIES
- 2. THE QUANTITIES LISTED ABOVE ARE ESTIMATES OF THE ASBESTOS CONTAINING MATERIALS PRESENT IN THE AREAS ON THIS DRAWING.

FOR

Ambient Environmental,
12 Colvin Avenue PH: 518–48:
Albany, New York 12206 FX: 518–48

ASBESTOS PRE-DEMOLITION SURVEY FOR BEECH-NUT NUTRITION CORPORATION

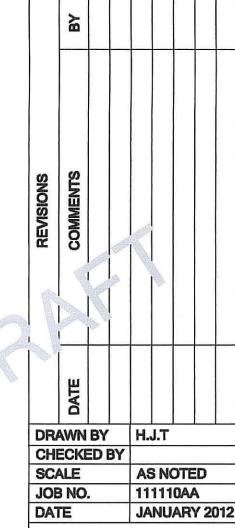

SECOND FLOOR BULK SAMPLE LOCATIONS AND ASBESTOS CONTAINING MATERIALS

LE

ASB106


DWG. NO.

EAST MAIN STREET


KEY PLAN

BUILDINGS - #17, #19, #21, #47 AND #65


SCALE:1/16*=1'-0*

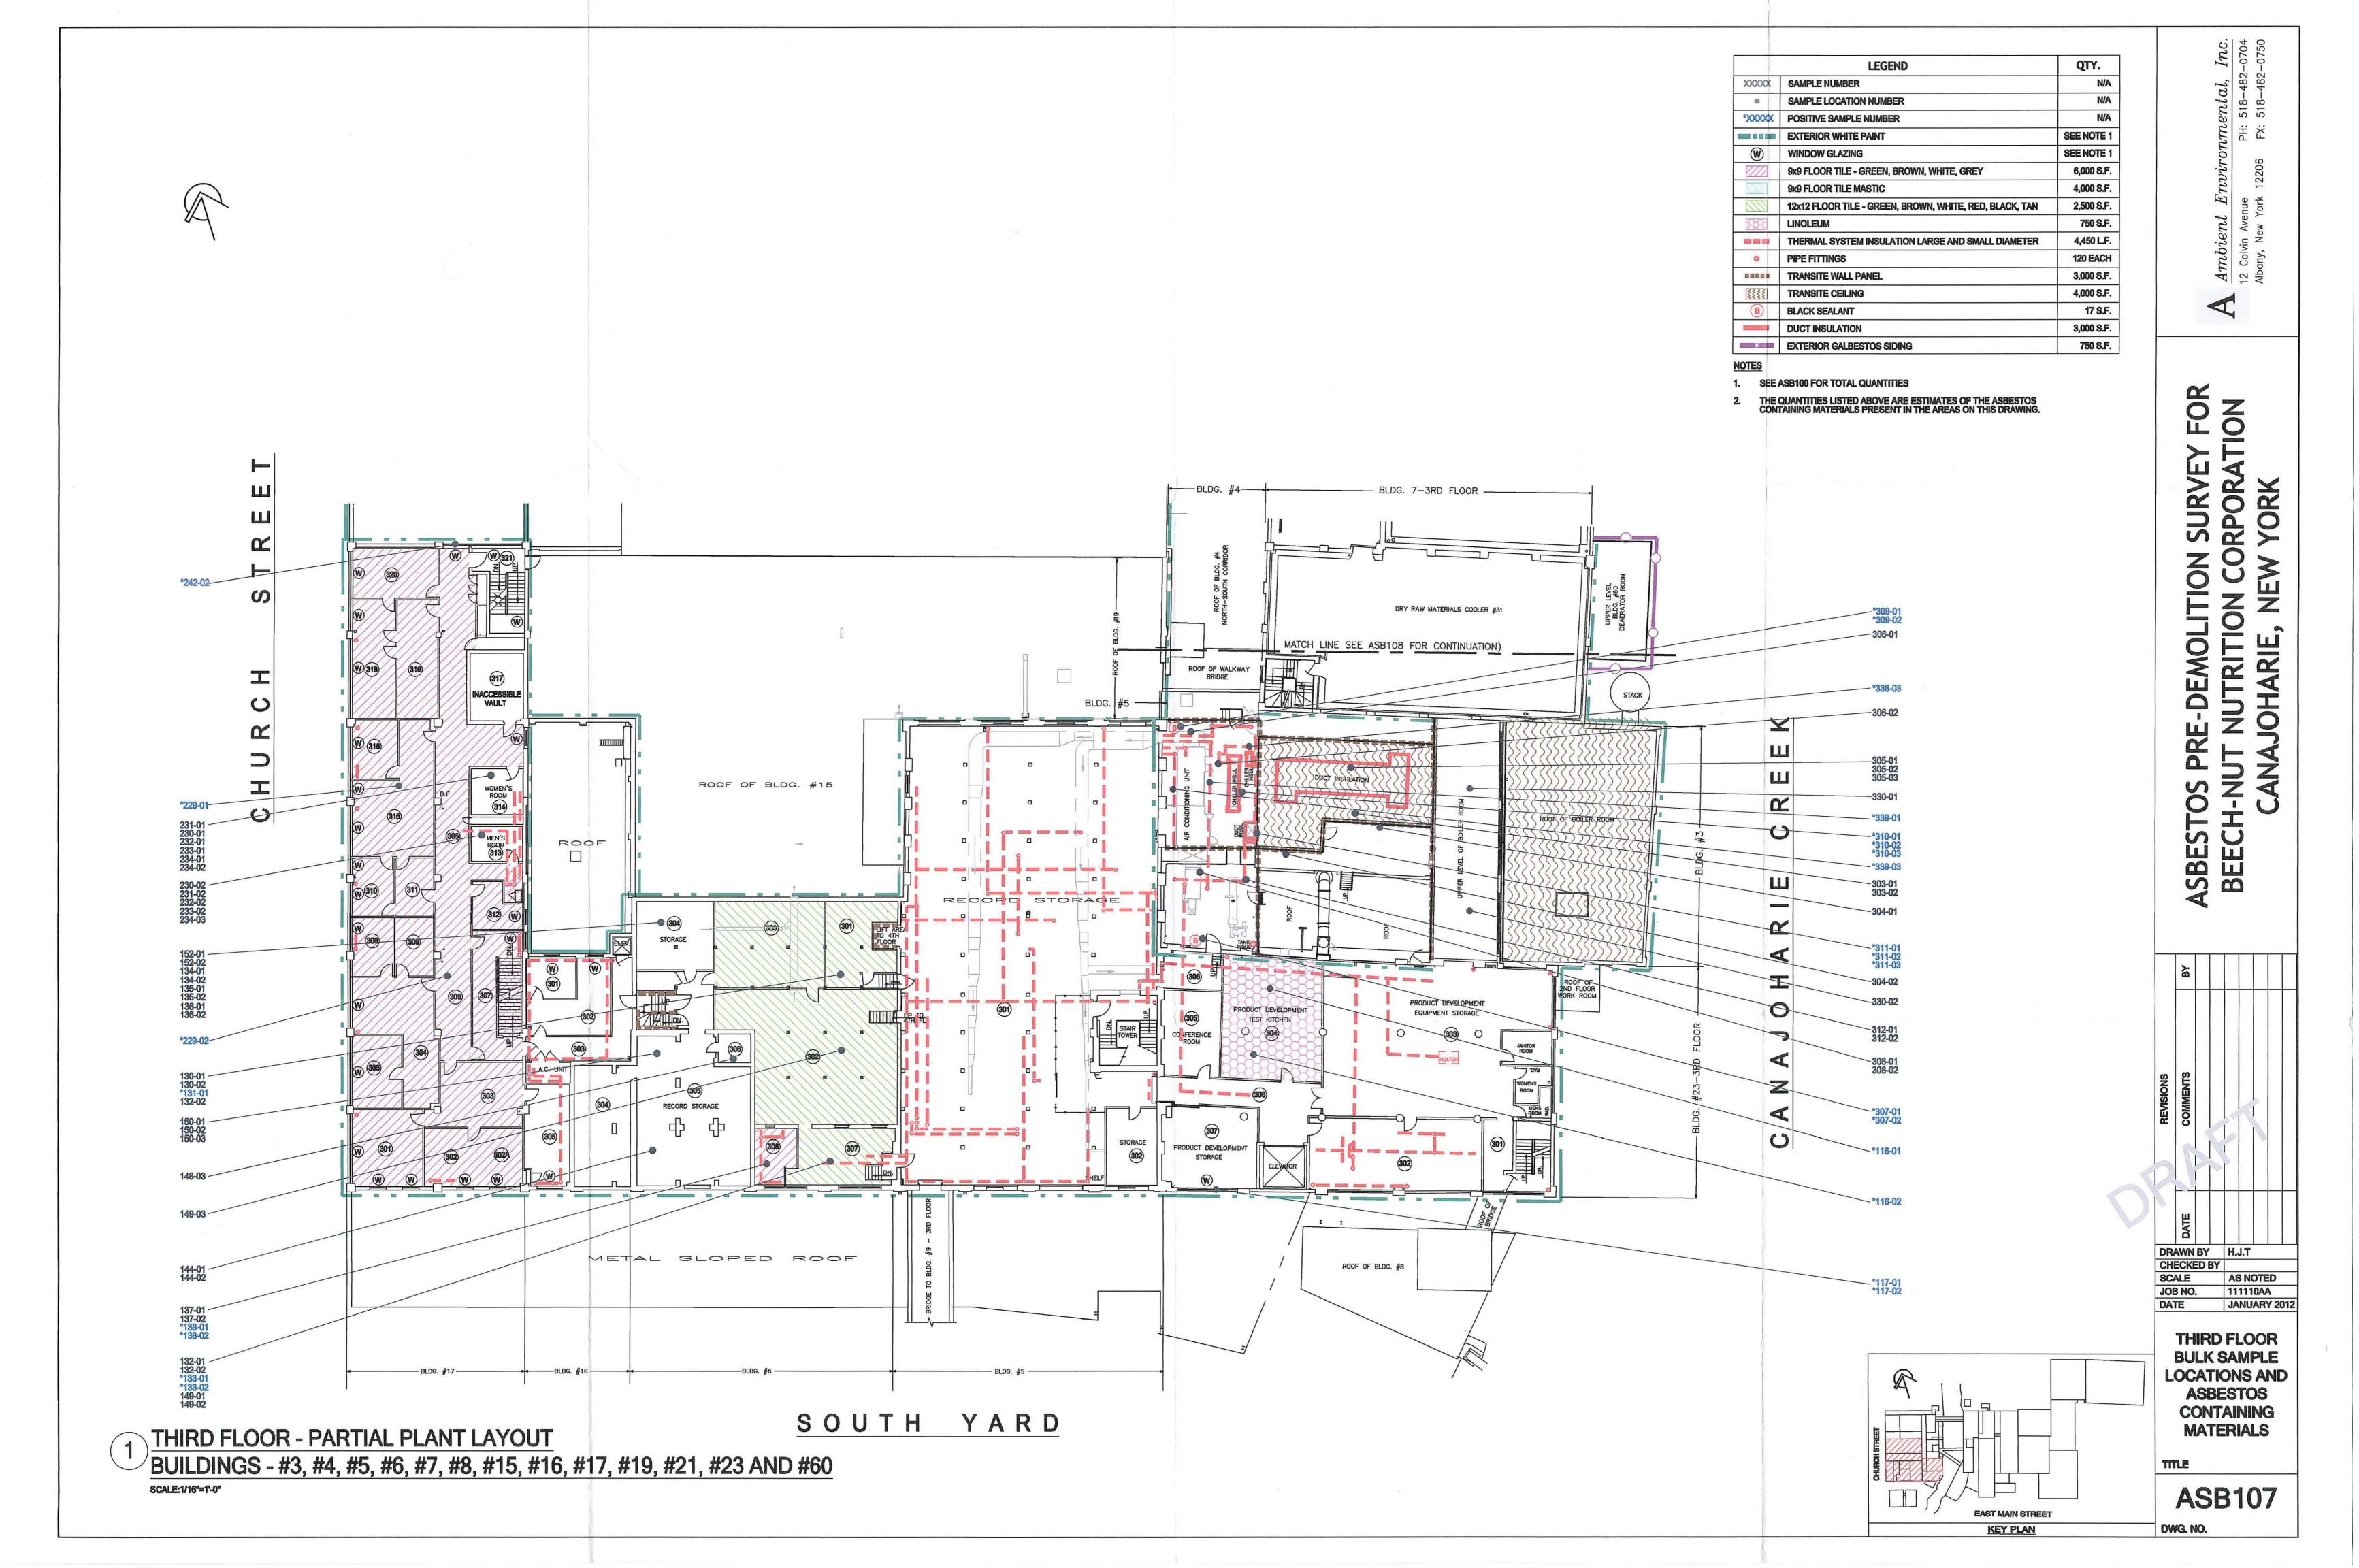

QTY. LEGEND XXXXX SAMPLE NUMBER NA SAMPLE LOCATION NUMBER *XXXXX POSITIVE SAMPLE NUMBER SEE NOTE 1 EXTERIOR WHITE PAINT 450 L.F. THERMAL SYSTEM INSULATION LARGE AND SMALL DIAMETER 15 EACH THE QUANTITIES LISTED ABOVE ARE ESTIMATES OF THE ASBESTOS CONTAINING MATERIALS PRESENT IN THE AREAS ON THIS DRAWING.

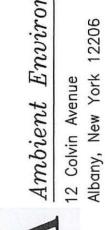

SURVEY FOR -DEMOLITION PRE 9 ASBEST(BEECH

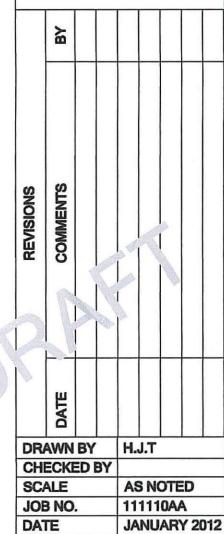


THIRD FLOOR BULK SAMPLE LOCATIONS AND ASBESTOS CONTAINING **MATERIALS**

EAST MAIN STREET

KEY PLAN


ASB108 DWG. NO.

NORTH YARD

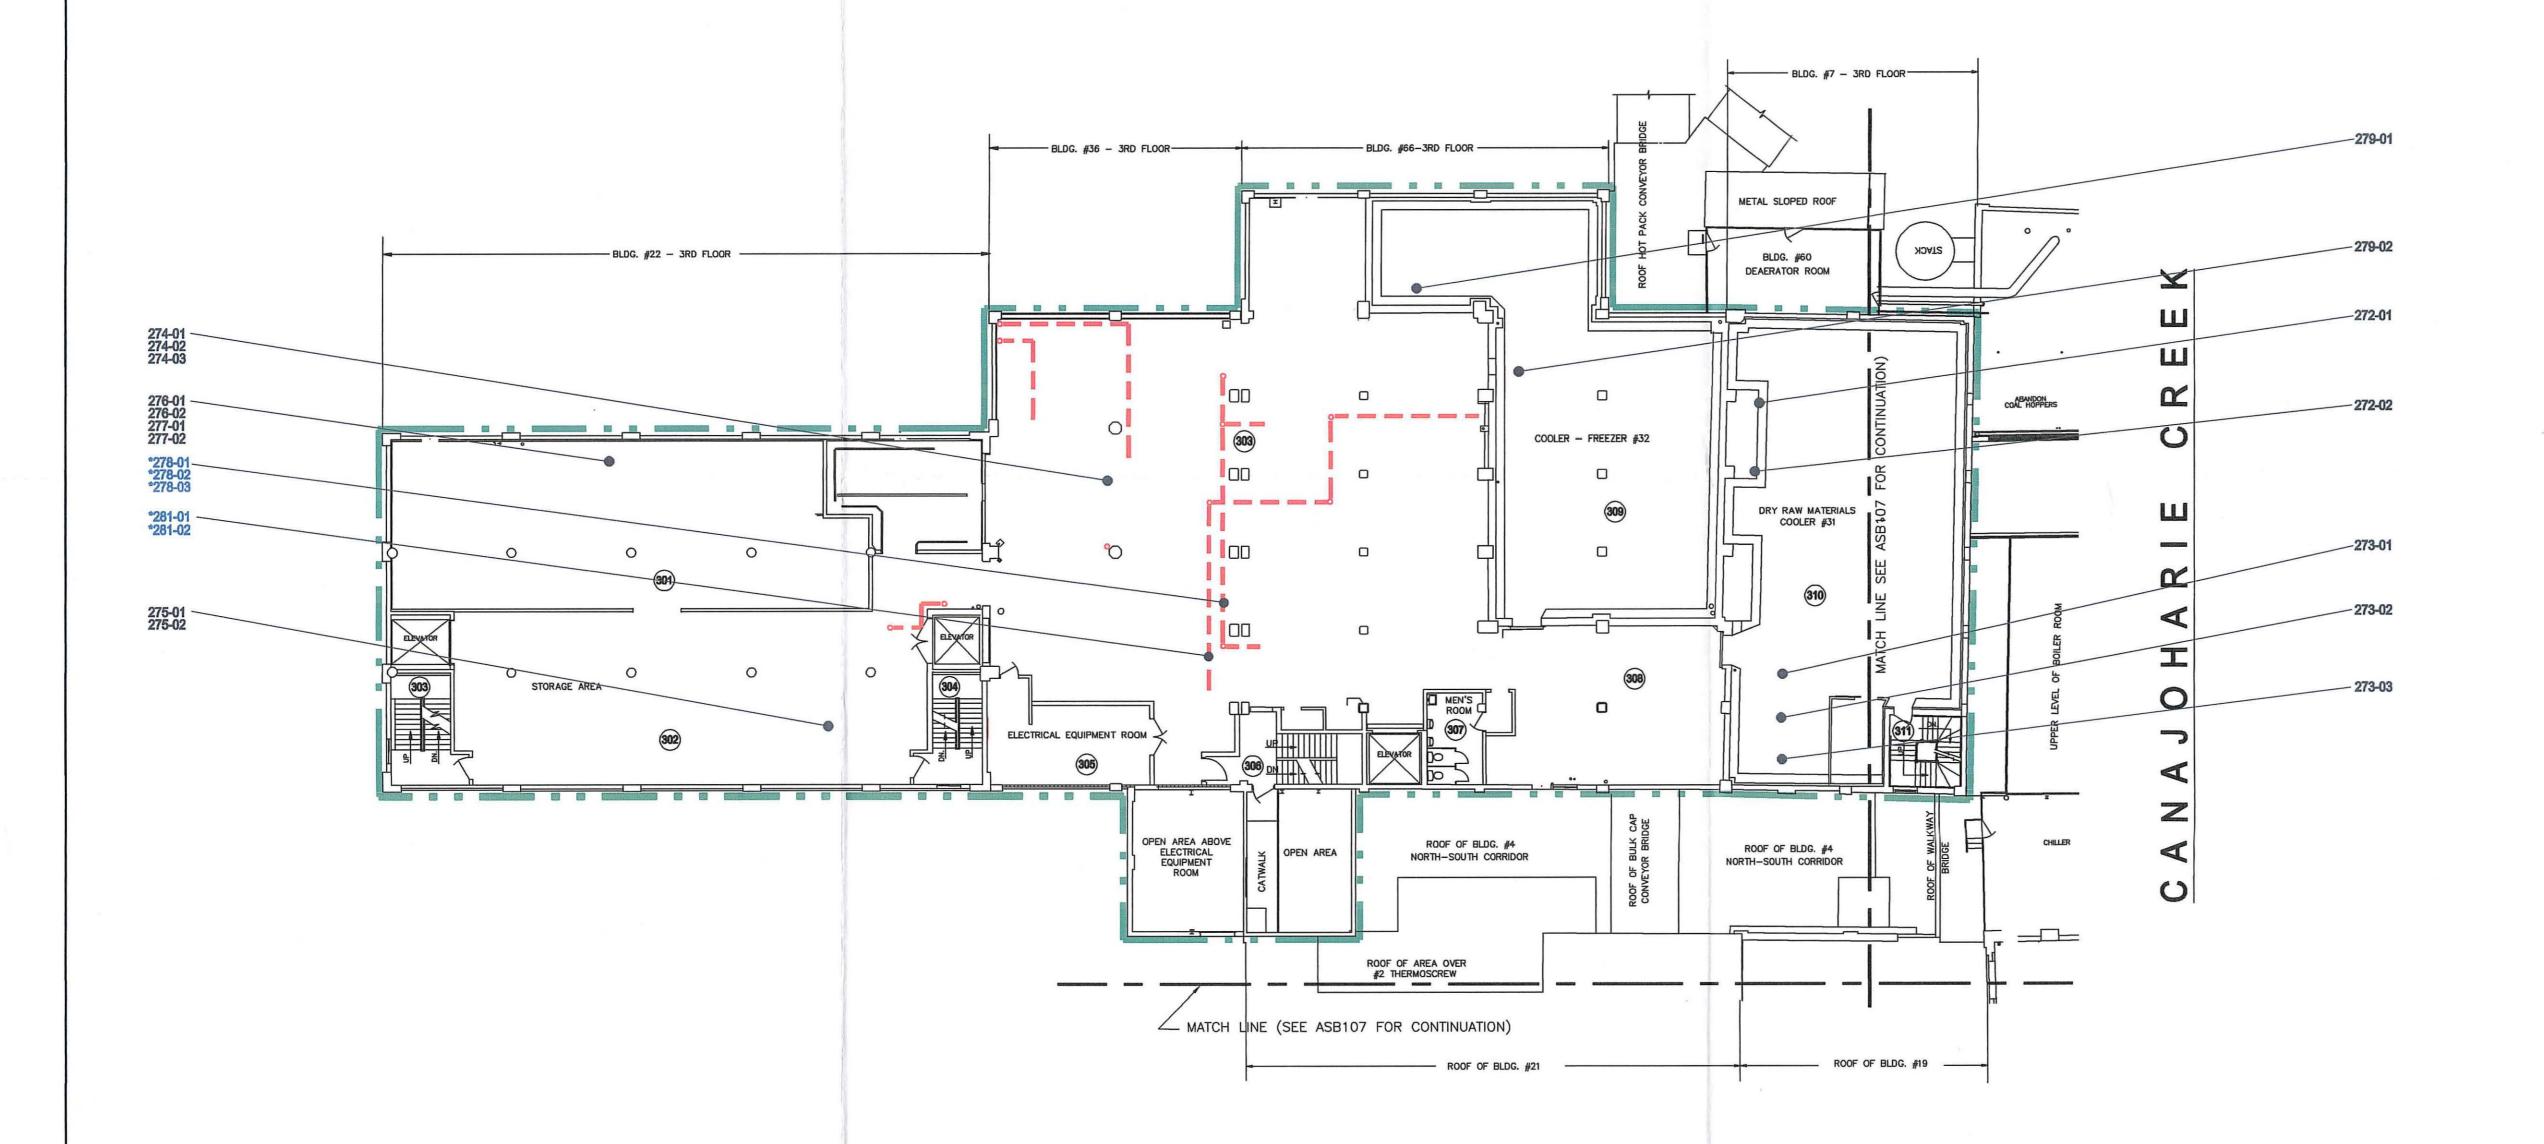

THIRD FLOOR - STRAINED FOOD BUILDING BUILDINGS - #4, #7, #20, #22, #35, #36, #60 AND #66

SCALE:1/16"=1'-0"

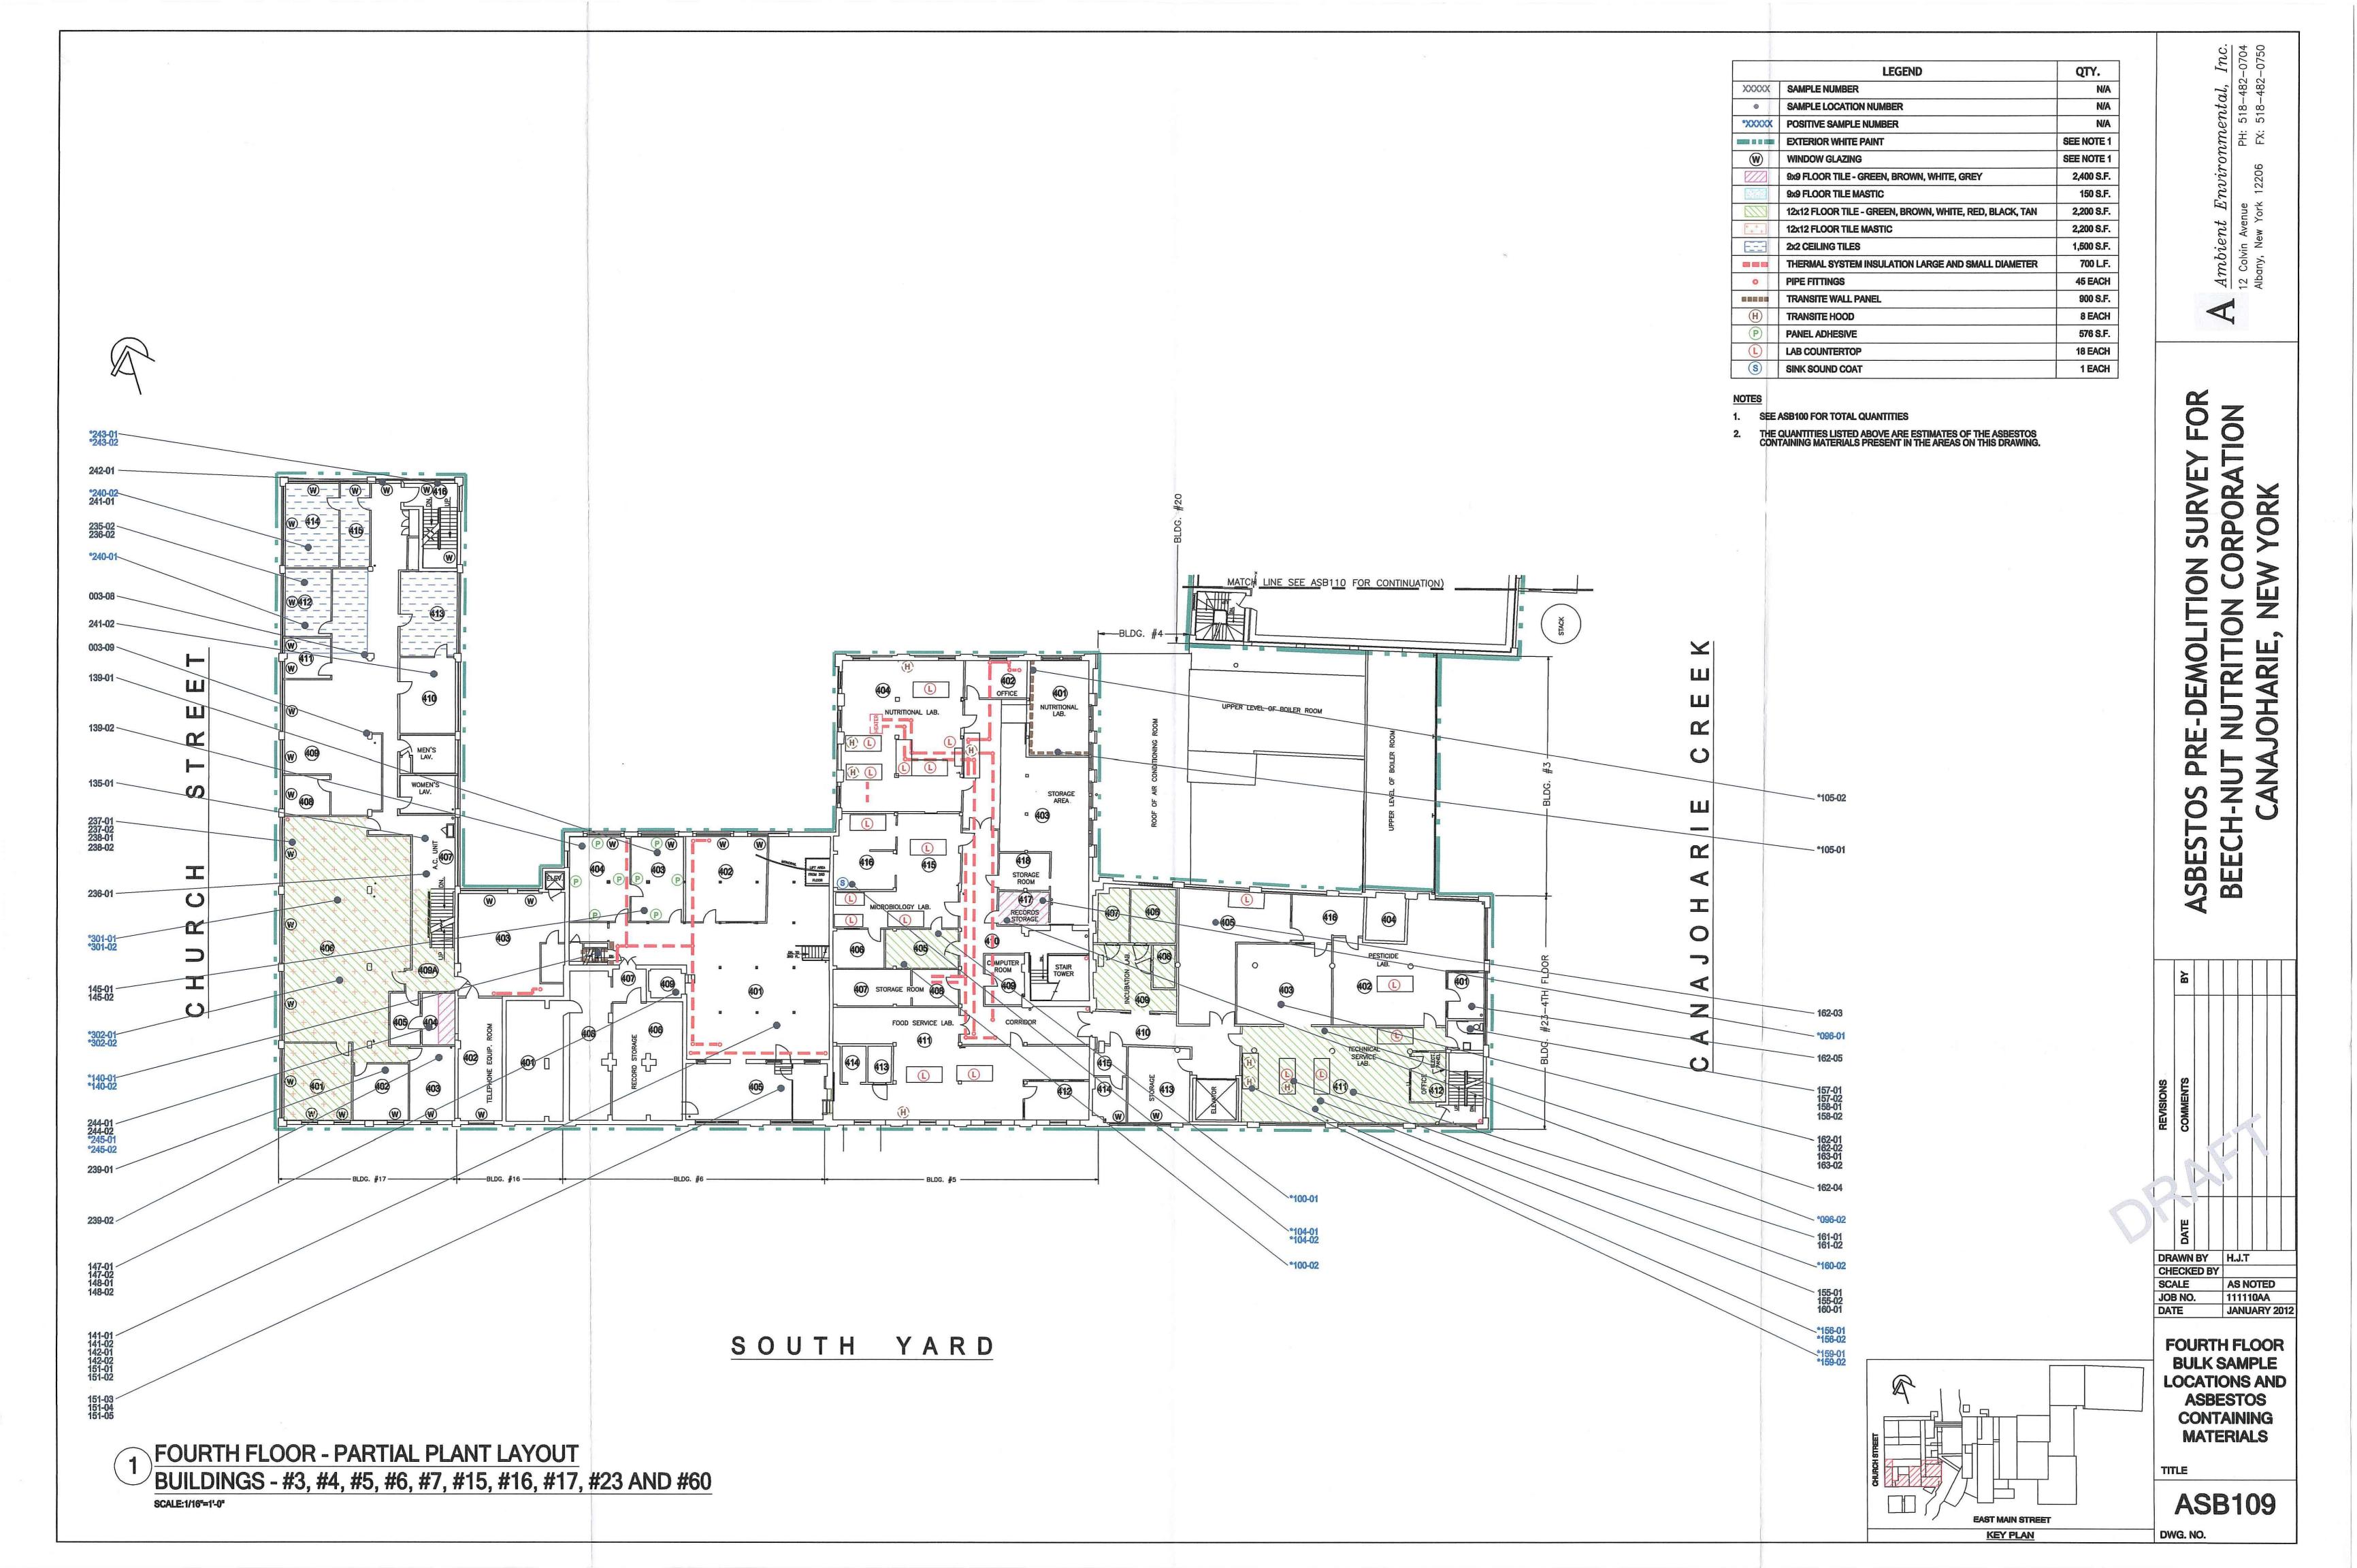



1	LEGEND	QTY.
XXXXX	SAMPLE NUMBER	N/A
	SAMPLE LOCATION NUMBER	N/A
*XXXXXX	POSITIVE SAMPLE NUMBER	N/A
	EXTERIOR WHITE PAINT	SEE NOTE
	THERMAL SYSTEM INSULATION LARGE AND SMALL DIAMETER	420 L.F
0	PIPE FITTINGS	42 EACH
~~~	INTERIOR SILVER PAINT	3,390 S.F

- 1. SEE ASB100 FOR TOTAL QUANTITIES
- THE QUANTITIES LISTED ABOVE ARE ESTIMATES OF THE ASBESTOS CONTAINING MATERIALS PRESENT IN THE AREAS ON THIS DRAWING.



## SURVEY FOR PRE-DEMOLITION 9 ASBEST( BEECH

	ВУ				
REVISIONS	COMMENTS				
	DATE				
	WN		H.J.	Т	-
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SCA				NOTED	
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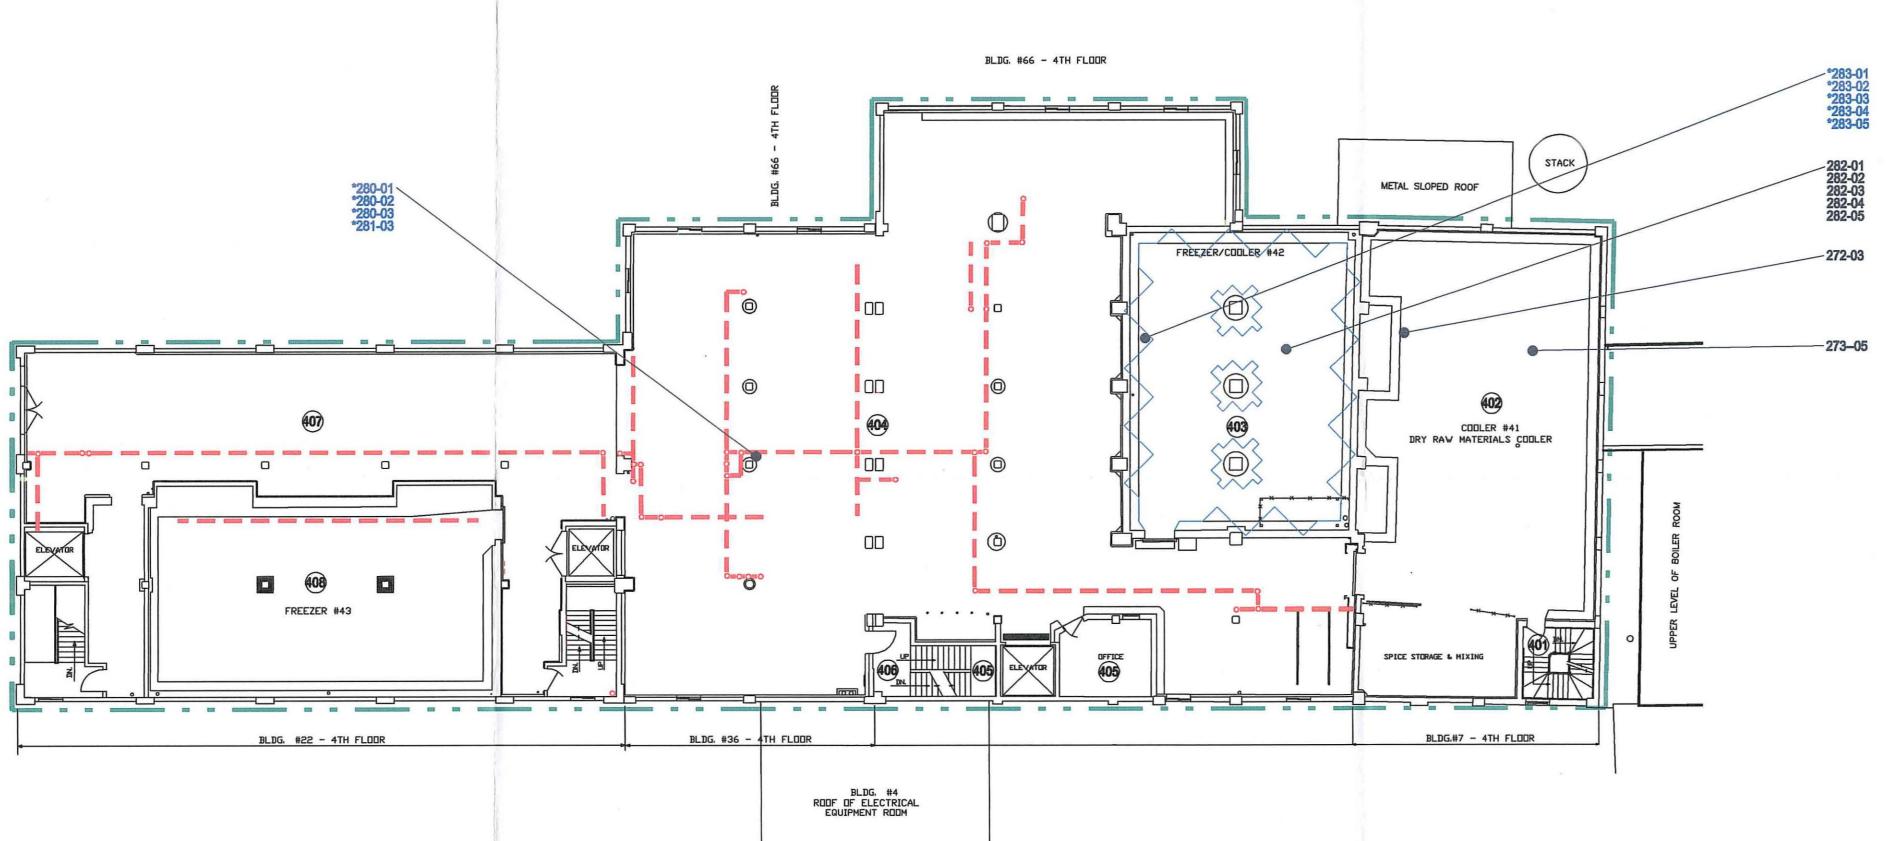
KEY PLAN

**FOURTH FLOOR BULK SAMPLE** LOCATIONS AND ASBESTOS CONTAINING **MATERIALS** TITLE


**ASB110** 

DWG. NO.

CANAJOHARIE CREEK



FOURTH FLOOR - STRAINED FOOD BUILDING BUILDINGS - #7, #20, #22, #35, #36, #60 AND #66

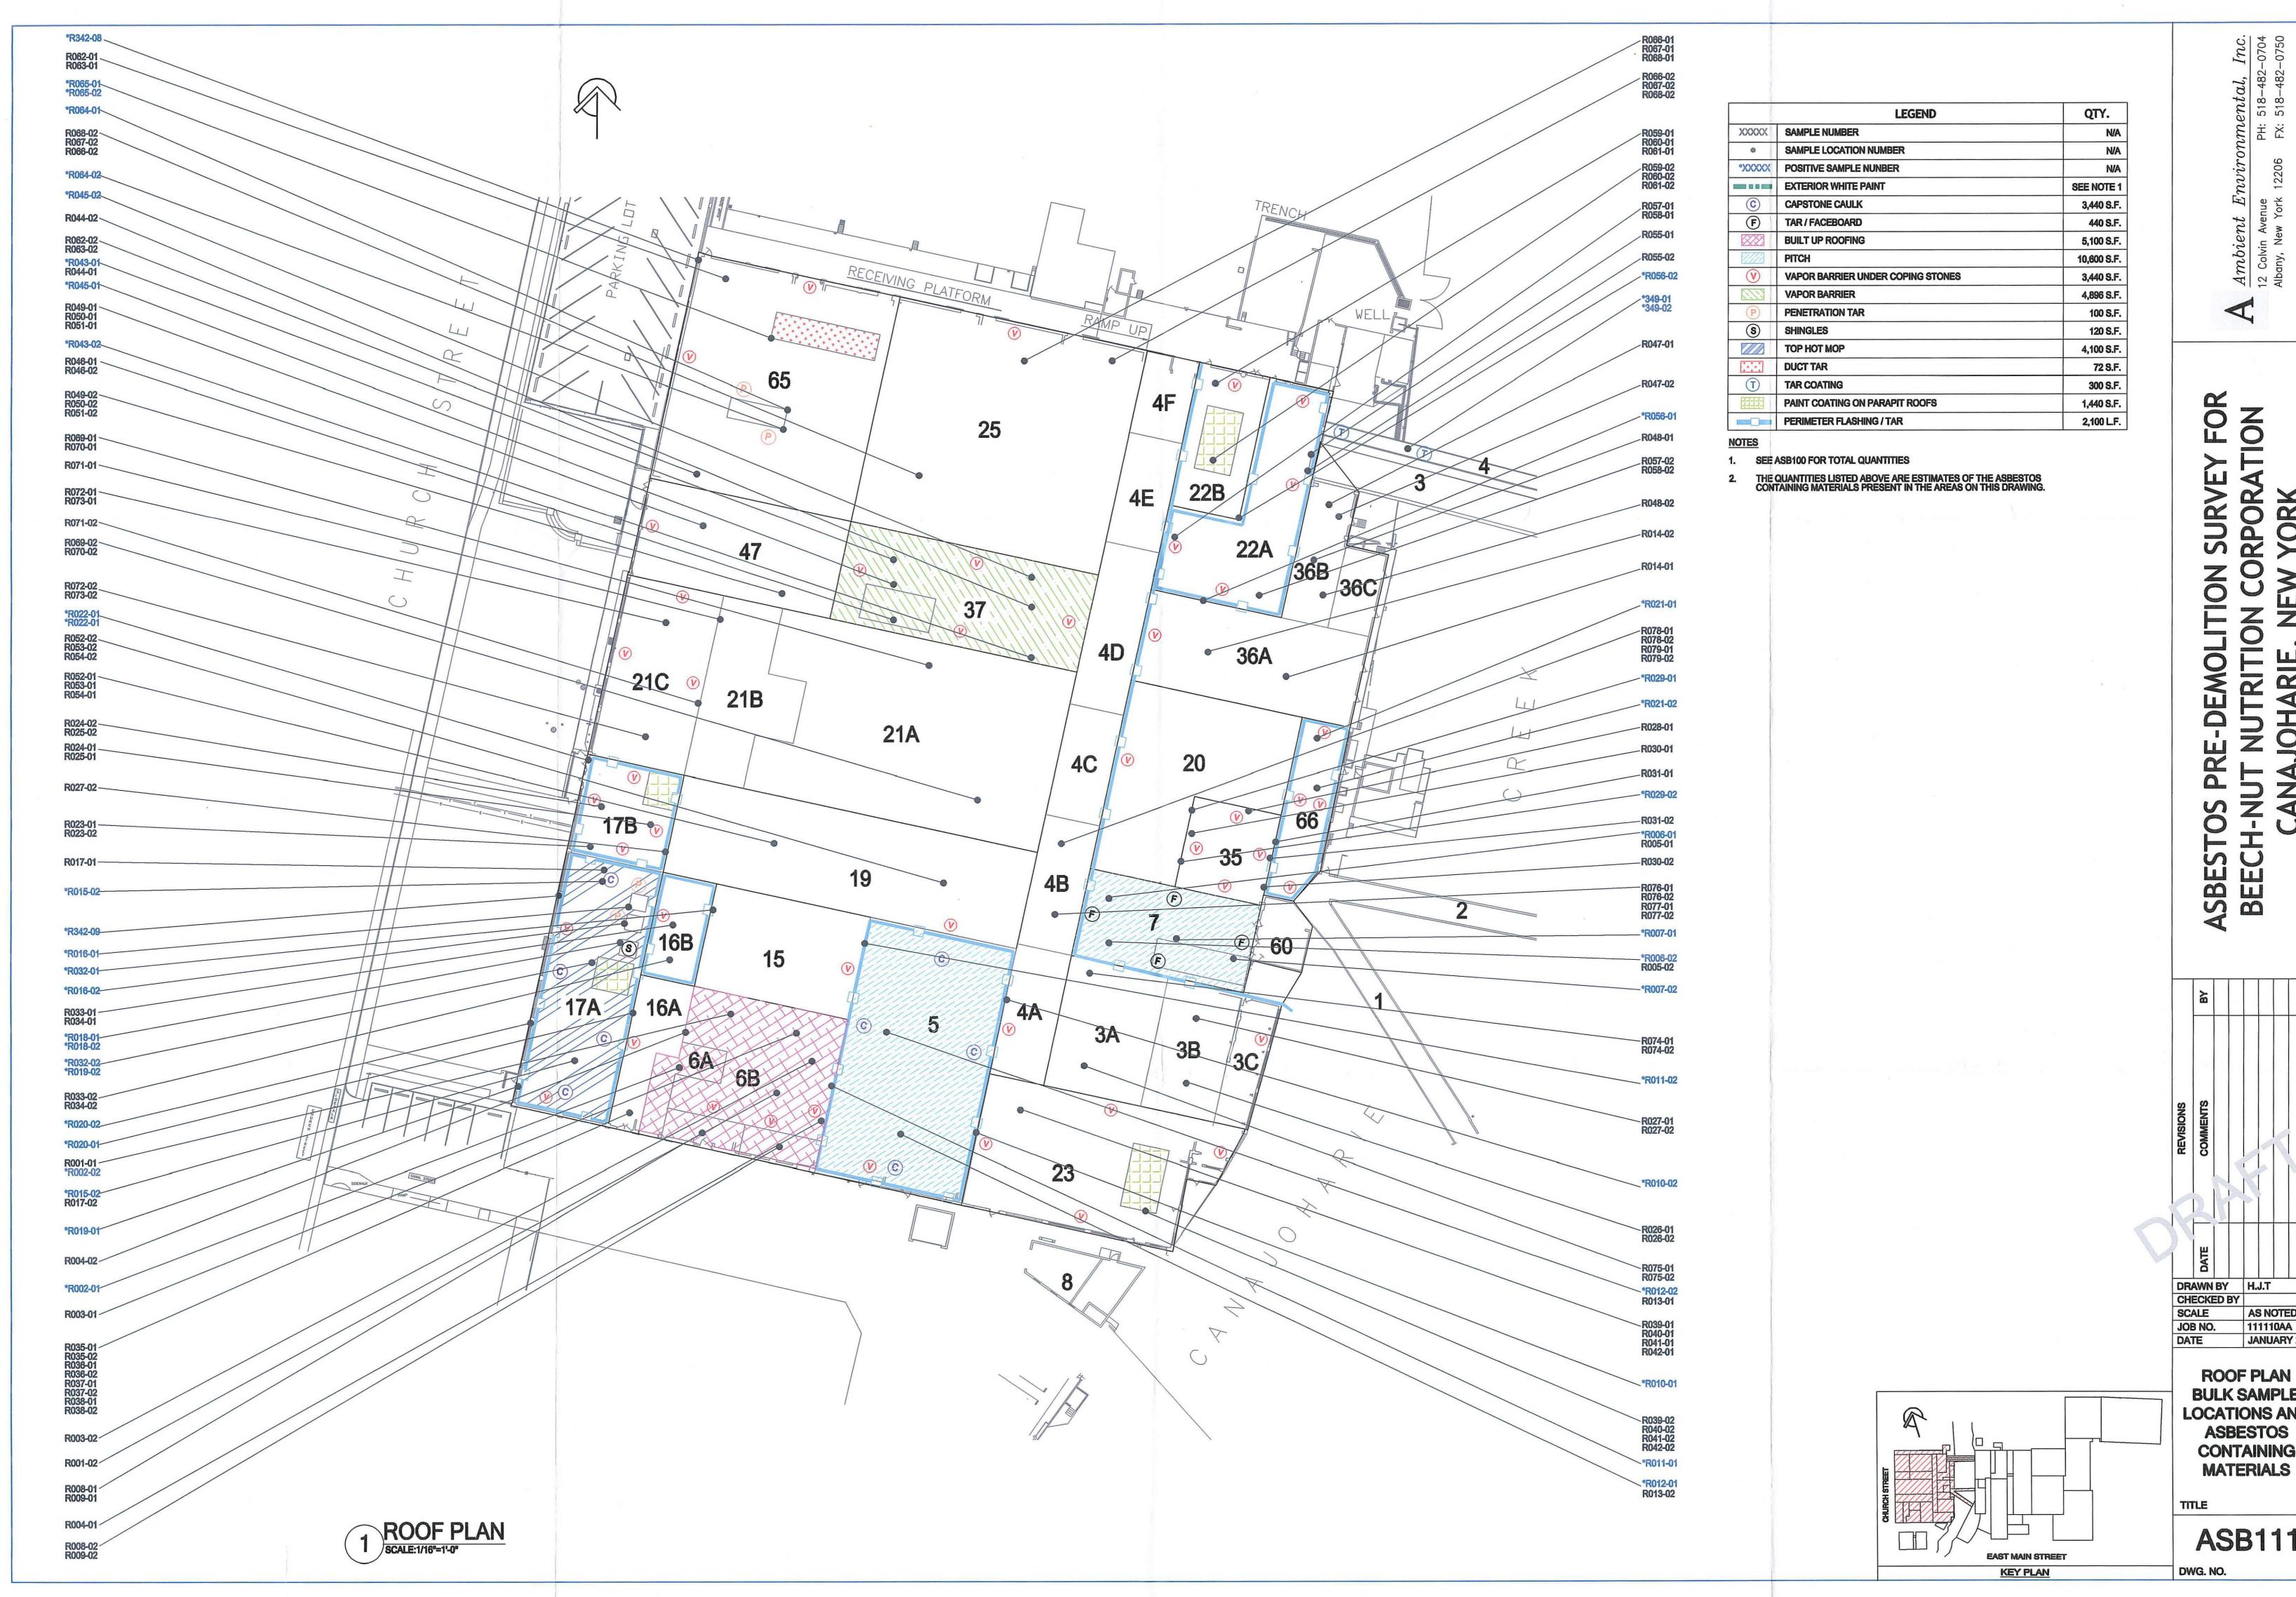

AS NOTED

111110AA JANUARY 2012

**BULK SAMPLE LOCATIONS AND** CONTAINING

**ASB111**